File No. 12	Fee: 43.75	Check or Receipt#: 9851
Supersedes File No.(s) <u>DR-2-2013/1</u> Scheduled Public Hearing Date:	12120008 or none	Initials: <u>US</u> Date Received <u>3-31-13</u>
(A)	OR CERTIFICATE OF DESIGN REVIEV GAHANNA PLANNING	COMMISSION MAR 3 1 2
*Required Information *Site Address1601 Eastgate Parky	way	To the contract of the contrac
A Lat man programme in the rest. District		*Zoning District OCT
*Business Name Formerly - Doc Tho	MC ADE TO DO DO DO STORE	NV -
		*Phone# _614-519-4296
*Business Address 1120 Venetian W	station from Committee lander	
*Applicant Name Ellen Thompson	THE STATE OF THE SECOND ST	
*Applicant Full Address 1120 Venetia		
*Applicant Phone# 614-519-4296		
*Designer/ Architect/ Engineer EMH&		
*Address 5500 New Albany Road,		*Phone 614-775-4400
*City/ State/ Zip Columbus, OH 430	hammy realdings band where	Fax 614-775-4800
*D/A/E Representative Craig Bohning		
processed and the second secon		g Design X Signage Other
		Original DR Application expired prices
to project completion. See DR-2-2		
I DOILDING CONSTRUCTION EXTER	NOR REMOVEMENT AND	9 ADBITYONS
	Submission Requireme	<u>ents</u>
submission) & nine (9) 11x17. Two (2) 1 (4) Submit one (1) reduced drawing suit (5) Submit one (1) color rendering of the foam core, gator board or other accepta (6) Submit a detailed list of materials. *Note: This application will not officially *Note: Planning Commission members application.	square foot 1/2 of OR1 copies of 24x36 (folded, 11 x 17 copies table to an 8 ½ x11 inch size project in plan/ perspectivable material.	not rolled, to 8 1/2 x 11 inch size prior ze. ve/ or elevation, mounted on 18 x 24 inch size s listed above have been received. the property prior to the hearing to review the property prior to the hearing to review the size of the property prior to the hearing to review the size of the property prior to the hearing to review the property prior to the hearing to review the size of the property prior to the hearing to review the size of the property prior to the hearing to review the size of the property prior to the hearing to review the size of the property prior to the hearing to review the size of the property prior to the hearing to review the size of the property prior to the hearing to review the size of the property prior to the hearing to review the size of the property prior to the hearing to review the property prior to the hearing to review the size of the property prior to the hearing to review the property prior to the hearing to review the property prior to the hearing the pri
*Applicant's Signature		*Date
9. Existing landscaping multiwal is	ADDDOVAL	oliharja Sodecepho P.
stated above, has been approved by th comply with any conditions approved	ne Gahanna Planning Com	of Gahanna, this certifies that this project, and single single shall comply with all building and zoning the shall comply with all building the shall be shall comply with all building the shall be shall building the shall be shall b
13. Provide breakdown of paridic	g specific required and sold	cera provided 13
Planning & Zoning Administrator		Date

SUBMITTAL REQUIREMENTS

SEE DR-2-2013

13.____

Applicant Planning & Or Agent Zoning Administrator I. GENERAL REQUIREMENTS A. All exhibits required for the permanent file (noted in the following paragraphs) must be able to be reduced to 8 ½ x 11 by folding, photo reduction, etc. (ALL 24x36 PLANS ARE TO BE FOLDED BY APPLICANT PRIOR TO SUBMISSION.) While large mounting boards. material samples, or other exhibits not meeting this criteria maybe used for Planning Commission presentation, the Commission does appreciate the use of the audio visual system whenever possible. B. Eleven (two 24x 36, nine 11x 17) black or blue-line prints of the plans including the items listed in section II below shall be submitted to the Planning & Zoning Administrator for presentation to the Planning Commission. An adequate number of color photographs (Polaroid-type acceptable) are C. C. required to illustrate the site, including buildings and other existing features as well as adjacent properties. Photos may also be used to illustrate installations on other sites that are similar to the applicant's proposal. D. Materials List II. BUILDING CONSTRUCTION, EXTERIOR REMODELING, AND ADDITIONS (INCLUDING PARKING LOTS AND LANDSCAPING) A. Site Plan. A site plan is required containing the following information: 1. Scale and north arrow. 2. Project name and site address; 3. All property and street pavement lines; 4. Existing and proposed contours; 5. Gross area of tract stated in square feet; 6. Proposed ingress and egress to the site, including on site parking area(s), parking stalls and adjacent streets. Delineate traffic flow with directional arrows and indicate the location of direction signs or other motorist's aids (if any); 7. The designation of required buffer screens (if any) between the parking area and adjacent property; 8. Location of all isolated existing trees having a diameter of six (6) inches or more; (Tree masses may be shown with a diagrammatic outline and a written inventory of individual trees exceeding 6" in caliber); 9. Existing landscaping that will be retained and proposed landscaping shall be differentiated and shown on the plan. The type, size, number. and spacing of all plantings and other landscape features must be illustrated; 10. Identify photograph location; 11. Location of all existing and proposed building on the site 12. Location of all existing (to remain) and proposed lighting standards.

13. Provide breakdown of parking spaces required and spaces provided

(see COG 1163);

SEE DR-2-2013

	14. Provide interior landscaping breakdown for paved surface (5% of paved surface required to be landscaped with one (1) tree per 100 square feet, see COG 1163)	14	
	15. Provide lot coverage breakdown of building and paved surface areas.	15	
В.	Elevations. Complete elevation from all sides of all proposed construction labeled North, South, East and West and related elevations of existing structures (if any) are required containing the following information:		
	1. Scale;	1	
	2. Changes in ground elevation;	2	
	3. All signs to be mounted on the elevations;4. Designation of the kind, color, and texture of all primary materials to be used;	4	
	Fenestration, doorways, and all other projecting and receding elements of the building exterior.	5	18
C.	Optional requirements at discretion of Planning Commission. 1. Scale model.	1.	
	2. Section Profiles.	2.	
	3. Perspective drawing.	1 2 3	
D.	Material Samples. Material samples are required for all exterior materials. For presentation purposes, a narrative description is required for Planning Commission file.	D	
E.	Lighting Standard Drawing. A scaled drawing of the proposed lighting standard(s) is required and should contain the following information: 1. All size specifications; 2. Information on lighting intensity (number of watts, isofootcandle diagram, etc., at least 1/2 foot candles required); 3. Materials, colors, and manufacturer's cut sheet; 4. Ground or wall anchorage details.	1 2 3 4	



Agreement to Build as Specified

Your signature below affirms that, as the applicant Ellen Thompson (Please Print - Applicant Name)
forfor(Business Name and/or Address)
you will build the project as approved and specified by the Planning Commission
for the City of Gahanna. You, as the applicant, also agree that any necessary change
to the project must go back through Planning Commission process to amend the plans.
Applicant Signature (Applicant Name/Applicant Representative) Date Mar 31 2015
(Signature of Notary)
(Date) SHARON R. PATTERSON NOTARY PUBLIC STATE OF OHIO COMM. EXPIRES AUGUST 13, 2017


MATERIAL LIST						
Item	Manufacturer Name	Color Name	Color Number			
Awnings						
Brick						
Gutters and Downspouts						
Lighting						
Roofing						
Siding						
Signs						
Stucco						
Trim						
Windows						

Planning Commission Information for All Applicants

- All required information must be submitted with the application. The Tuesday, four (4) weeks prior
 to the Public Hearing Date, by 5:00 p.m., is the deadline for acceptance of all applications. No
 application will be forwarded to Planning Commission until <u>all information</u> is received in the
 Planning & Zoning Office.
- 2. It is the responsibility of the applicant to have a court reporter present, at the applicant's expense, if they wish to have a verbatim transcript of the meeting. Council office must be advised in advance if a court reporter is going to be present.
- 3. Reduced drawings suitable to an 11x17 inch size must be submitted. If an application is amended at any time during the process, a new reduced drawing must be submitted as well as any full size drawings requested.
- 4. Agendas will be mailed to the applicant on the Friday prior to the Planning Commission meeting. If the agenda is to go to someone other than the applicant, it needs to be noted on the application.
- 5. If a list of Contiguous Property owners needs to be submitted with an application, it must be compiled in a list on a separate sheet of paper. This must include mailing name and address of property owner. Showing them only on one of the plan sheets is not acceptable.
- 6. For Design Review applications, a materials list, unless otherwise instructed by the Planning & Zoning Administrator, must be submitted with the application. If materials are changed during the process, then a new materials list must be submitted.
- 7. For Multi-tenant ground sign & Master Sign Plan applications, location must be noted on a site plan. Also notate location on site plan for a freestanding sign or on building elevation for a wall sign. Color renderings must be submitted.
- 8. Please review "Submission Requirements" on any application before submitting to the Planning & Zoning Division.
- 9. Copies of specific sections of the zoning code are available in the Zoning Office at no charge. The entire zoning code with a map is available in the Council Office at a cost of \$25.00. Zoning Code is available on line and can be found @ www.gahanna.gov/departments/development/planning.asp under Code Ordinances.
- 10. Planning Commission members may visit the property prior to the hearing to review the application.



Google Maps – Street View 3-30-15

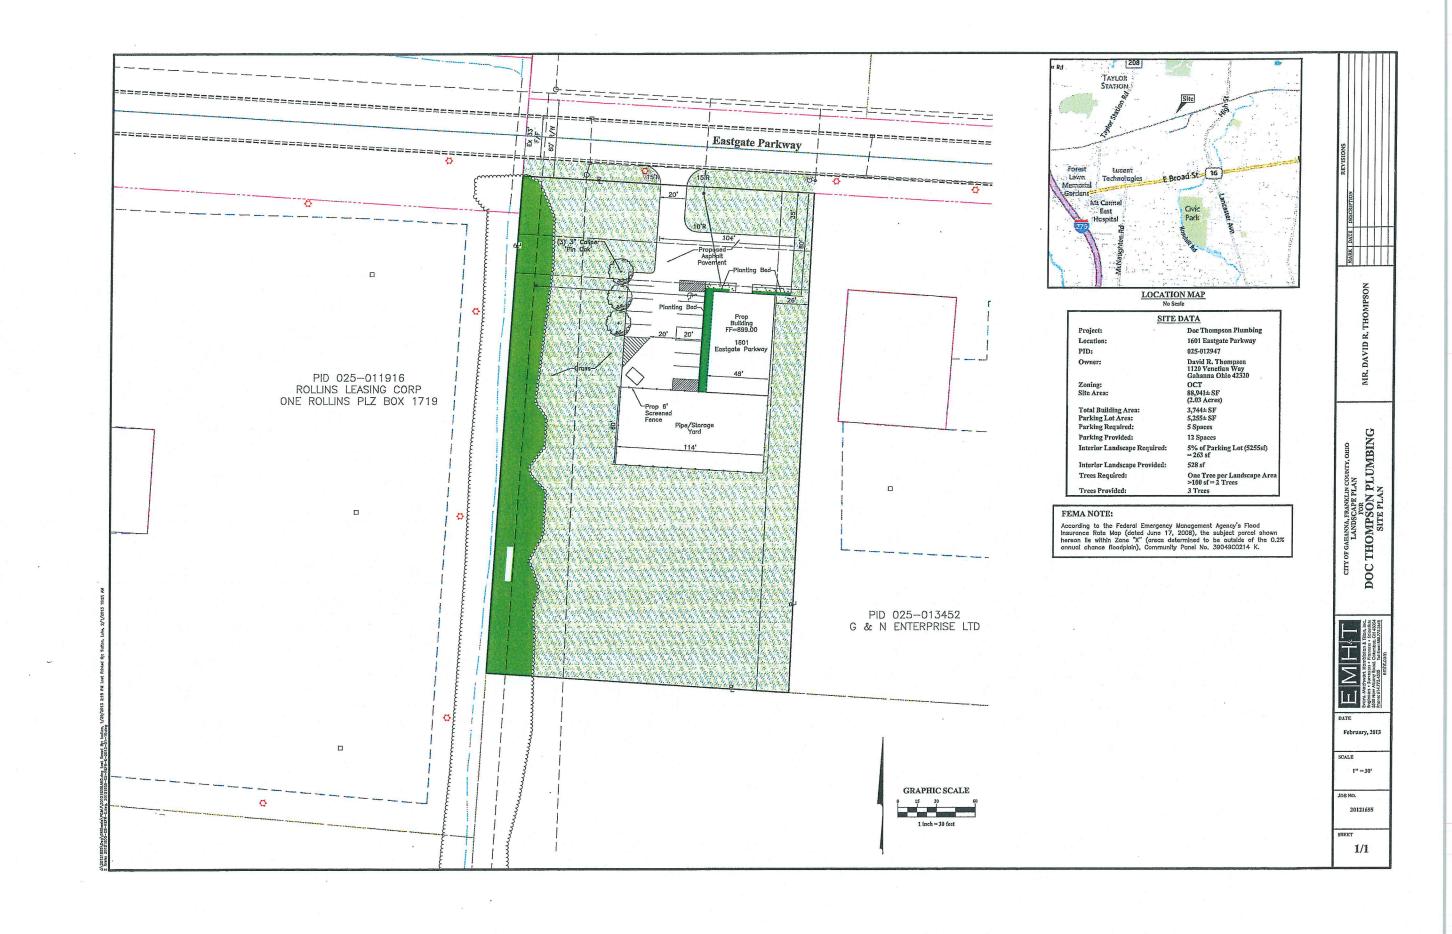

DOC THOMPSON PUTMBIN

GAHANNA, OH

BUILDING SPECIFICATIONS AND GENERAL NOTES

OWNERS INFORMATION:

BUILDING REQUIREMENTS:

USE OF BUILDING: SIORAGE WAREHOUSE GROUP.S-1
DESIGN CODE: DESIGN CODE: 2009 OHIO. BUILDING. CODE
CCUPANCY CATEGORY: 2
2

BUILDING DESIGN LOADS:

SNOW WIND		SEISMIC	TRUSS DEAD LOADS			
$ \begin{array}{lll} (Pg) &=& 20.0 \ PSF \\ (Ce) &=& 0.90 \\ (Is) &=& 1.00 \\ (Ct) &=& 1.20 \\ (Pf) &=& 15.12 \ PSF \\ (Cs) &=& 0.94 \\ (Ps) &=& 14.18 \ PSF \\ (Lr) &=& 20.00 \ PSF \end{array} $	B.W.S. = <u>90 MPH</u> (Iw) = <u>1.00</u> EXPOSURE = <u>C</u> .	SEISMIC IMPORTANCE FACTOR: SPECIRA RESPONSE COEFFICIENT SDS: SPECIRA RESPONSE COEFFICIENT SDI: SITE CLASSIFICATION: SEISMIC DESIGN CATEGORY:	1.00 .155 .093 D. A.	DLTC DLBC	=	4 PSF 5 PSF

PLEASE NOTE:

DESIGNER LIABILITY LIMITED TO THE PREPARATION OF THE DRAWINGS WITH THE PARAMETER CONTRACTED AND ASCERTAINING TO CODE COMPLIANCE

THESE DRAWINGS ARE DIAGRAMMATIC AND SHALL NOT BE SCALED. ADDITIONAL DATA SHALL BE RECEIVED FROM THE ENGINEER THROUGH WRITTEN CLARIFICATION ONLY, VERIFY ALL EXISTING CONDITIONS, ELEVATIONS, & DIMENSIONS BEFORE PROCEEDING WITH ANY PORTION OF ANY WORK.

NO CHANGES, MODIFICATIONS, OR DEVIATIONS SHALL BE MADE FROM THESE DRAWINGS OR SPECIFICATIONS WITHOUT FIRST SECURING WRITTEN PERMISSION FROM THE ENGINEER.

WHITEUS ISCUSING WATHER FERMISSING FLOW THE ENGINEER.

"WHERE LACK OF INFORMATION, OR ANY DISCREPANCY SHOULD APPEAR IN THE DRAWINGS OR SPECIFICATIONS, REQUEST WRITTEN INTERPRETATION FROM THE ENGINEER BEFORE PROCEEDING WITH THAT PORTION OF THE WORK - SOIL CLASSIFICATION #4 (FIRM) BASED ON ASABE EP486.1 (CLASS OF MATERIAL: SW, SP, SM, SC, GM AND GC)

- A SOIL BEARING VALUE ASSUMED AT 2020 PSF ALL FOOTINGS AND SLAB TO BEAR ON UNDISTURBED INORGANIC SOIL OR SOIL COMPACTED TO \$5% MODIFIED PROCTOR DENSITY.

CONCRETE: LUMBER:

COLUMNS:

SOIL:

- CONCRETE SHALL BE IN ACCORDANCE WITH ACI 318-08 CONCRETE SHALL HAVE A MINIMUM COMPRESSIVE STRENGTH OF 3000 PSI AT 28 DAYS.

ALL WOOD CONSTRUCTION SHALL BE OF MATERIALS SHOWN AND WORKMANSHIP SHALL BE IN ACCORDANCE TO THE NATIONAL FOREST PRODUC'S ASSOCIATION SPECIFICATIONS FOR WOOD CONSTRUCTION.

 ALL LUMBER IN CONTACT WITH CONCRETE ABOVE GRADE SHALL BE TREATED IN ACCORDANCE TO AWPA U1-10 UC3B OR BETTER REQUIREMENTS. - ALL LUMBER BELOW GRADE SHALL BE TREATED IN ACCORDANCE TO AWPA U1-10 UC4B OR BETTER REQUIREMENTS.

-- ALL SIDEWALL COLUMNS ARE 3-PLY 2x8 2400f MSR SYP LAMINATED CCLUMNS, RIVET CLINCHED, WITH STEEL REINFORCED JOINTS UNLESS SPECIFIED OTHERWISE. ALL ENDWALL COLUMNS ARE 3-PLY 2x8 2400f MSR SYP LAMINATED COLUMNS, RIVET CLINCHED, WITH STEEL REINFORCED JOINTS UNLESS SPECIFIED OTHERWISE.

TRUSSES: DESIGNED IN ACCORDANCE TO 2009 OHIO BUILDING CODE TPI APPROVED THIRD PARTY INSPECTED

STEEL PANEL:

- PRO-RIB STEEL PANEL

STRUCTURAL STRENGTH ASTM-A653 GRADE 80 (FULL HARD STEEL) 82000 PSI MINIMUM TENSILE STRENGTH

SOFFIT PANELS:

FRAMING FASTENERS: PANEL FASTENERS:

- GALVANIZED THREADED HARDENED STEEL RINGSHANK NAILS.

GRADE:

- COLOR MATCHED GALVANIZED WOODGRIP SCREWS, #9 DIAMETER, 1/4" HEX HEAD. - ALL GRADES TO SLOPE AWAY FROM BUILDING AT A MIN. 2% GRADE FOR PROPER DRAINAGE.

CONSTRUCTION BRACING: - TEMPORARY BRACING DURING CONSTRUCTION SHALL BE CONTRACTORS RESPONSIBILITY. REFER TO THE BCSI-B1 AND/OR B10 SUMMARY SHEET "GUIDE FOR HANDLING, INSTALLING, RESTRAINING AND BRACING OF TRUSSES", BY THE TRUSS PLATE INSTITUTE (TP) AND THE WOOD TRUSS COUNCIL OF AMERICA (WTCA). HEATING, VENTING, AND AIR CONDITIONING REQUIREMENTS WERE NOT ADDRESSED ON THE DRAWING AND SHOULD BE APPROVED BY LOCAL OFFICIALS.

HVAC:

- PLUMBING REQUIREMENTS WERE NOT ADDRESSED ON THE DRAWING AND SHOULD BE INSTALLED IN ACCORDANCE WITH REQUIRED BUILDING CODES.

PLUMBING:

- ELECTRICAL REQUIREMENTS WERE NOT ADDRESSED ON THE DRAWING AND SHOULD BE INSTALLED IN ACCORDANCE WITH THE NATIONAL ELECTRICAL CODE AND ANY LOCAL CODES.

ELECTRICAL:

EXIT LIGHTS:

EXIT SIGNS SHALL BE ILLUMINATED AT ALL TIMES. TO ENSURE CONTINUED ILLUMINATION FOR A DURATION OF NOT LESS THAN 90 MINUTES IN CASE OF PRIMARY POWER LOSS, THE EXIT SIGNS SHALL BE CONNECTED TO AN EMERGENCY PLECTRICAL SYSTEM PROVIDED FROM STORAGE BATTERIES, UNIT FOUIPMENT OR AN ON-SITE GENERATUR. THE INSTALLATION OF THE EMERGENCY POWER SYSTEM SHALL BE IN ACCORDANCE WITH THE ICC ELECTRICAL CODE. ACCESSIBLE PARKING SHALL COMPLY WITH ICC/ANSI A117.1 CHAPTER 5.

- SHALL COMPLY WITH ICC/ANSI A117.1 CHAPTER 4.

SHALL COMPLY WITH ICC/ANSI A117.1 CHAPTER 3 SECTION: 309. HANDLES, PULLS, LATCHES, AND OTHER OPERATING DEVICES ON ACCESSIBLE DOORS SHALL HAVE A SHAPE THAT IS EASY TO GRASP WITH ONE HAND AND DOES NOT REDUIRE TIGHT GRASPING. TIGHT PINCHING, OR TWISTING OF THE WRIST TO OPERATE. LEVER OPERATED MCHANISMS, PUSH-TYPE MECHANISMS, AND U-SHAPED HANDLES ARE ACCEPTABLE DESIGNS. WHEN SLIDING DOORS ARE FULLY OPERATED. OPERATING HARDWARE SHALL BE EXPOSED AND USABLE FROM BOIT SIDES. HARDWARE FOR USE EXPOSED AND USABLE FROM BOIT SIDES. HARDWARE FOR USE OF THE METHOD OF THE ACCESSIBLE DOOR PASSAGE SHALL BE MOUNTED NO HIGHER THAN 48" (1220 MM) ABOVE FINISHED FLOOR THE HRESHOLD OF SERVICE DOORS MAY NOT EXCEED 1/2" ON EITHER SIDE OF THE DOOR.

FIRE EXTINGUISHERS:

- SHALL BE INSTALLED, PROVIDED, AND MAINTAINED AS SPECIFIED IN NFPA NO. 10 (BY OTHERS).

DURESS:	1601 EASTGATE PARKWAY
ITY:	GAHANNA
TATE.	OH
IP:	43230
OUNTY:	FRANKLIN

BUILDING INFORMATION:

	SHEET INDEX
SHEET #	SHEET DESCRIPTION
1 OF 14	GENERAL NOTES AND SITE PLAN
2 OF 14	ELEVATIONS .
3 OF 14	FIRST FLOOR PLAN AND COLUMN, FOOTING & BRACKET SCHEDULI
4 OF 14	FIRST FLOOR ROOM LAYOUT AND FLOOR JOIST LAYOUT
5 OF 14	ROOF FRAMING PLAN
6 OF 14	WALL SECTION AND SECTION DETAILS
7 OF 14	WALL SECTION AND SECTION DETAILS
8 OF 14	TRUSS AND MISCELLANEOUS FRAMING DETAILS
9 OF 14	ENDWALL FRAMING AND ENDWALL SECTION
10 OF 14	ENDWALL FRAMING AND ENDWALL SECTION
11 OF 14	ISTAIR DETAILS
12 CF 14	MISCELLANEOUS FRAMING AND STEEL DETAILS
13 OF 14	STEEL LAYOUTS .
14 OF 14	HESTROOM AND DRINKING FOUNTAIN DETAILS




ROJECT TITL	E:		
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DOC	THOMPSON	PLUME	SING
	GAHANNA, OI	- I	


SHEET TITLE GENERAL NOTES AND SITE PLAN

		REVISIONS		PROFESSIONAL ENGINEER:	FILE N	AME:
KQ.	DATE	DESCRIPTION	, BY	JEFF MURRAY	W29	1120H01
Λ	10/08/12	REMOVE SITE PLAN	T.M.G	PLAN DESIGNER:	DATE:	•
2				LOUISE EWALD	09-	18-2012
3				DRAWN BY:	SCALE:	-
4				KEITH SCHEUNEMANN	AS	NOTED


SHEET NO.


OF 14

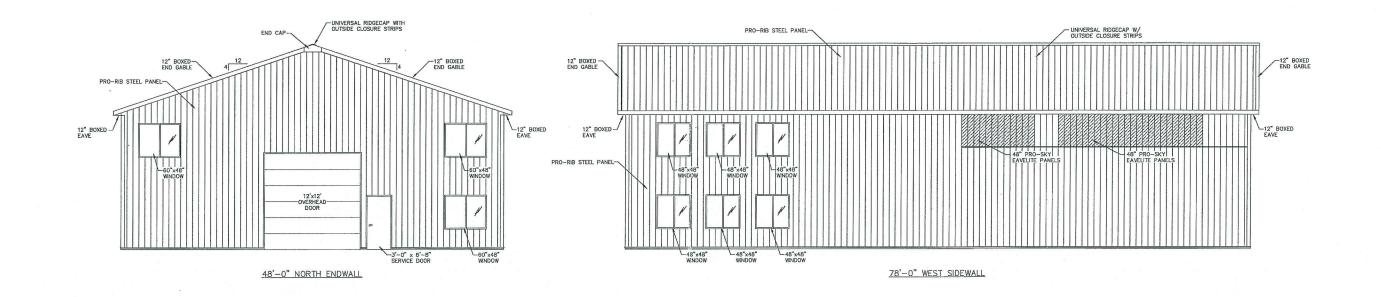

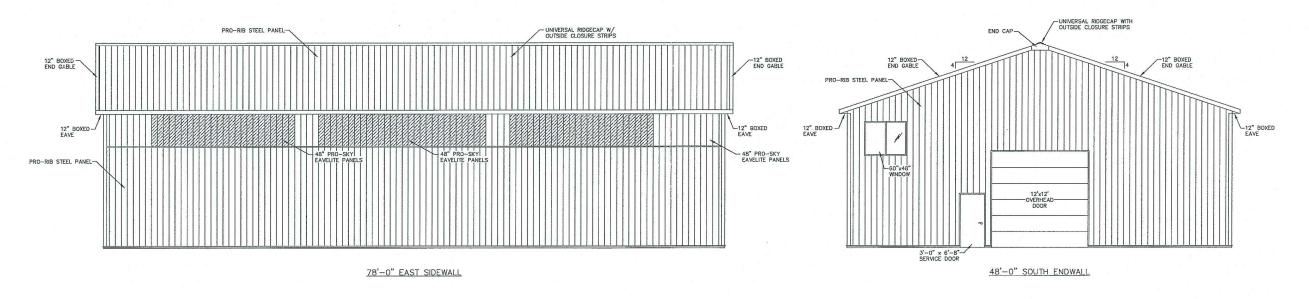

ELEVATIONS SCALE: 3/16"=1'-0"

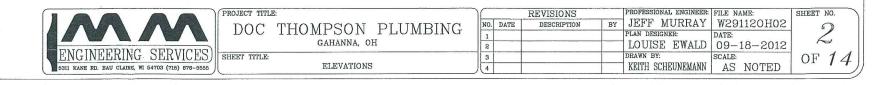

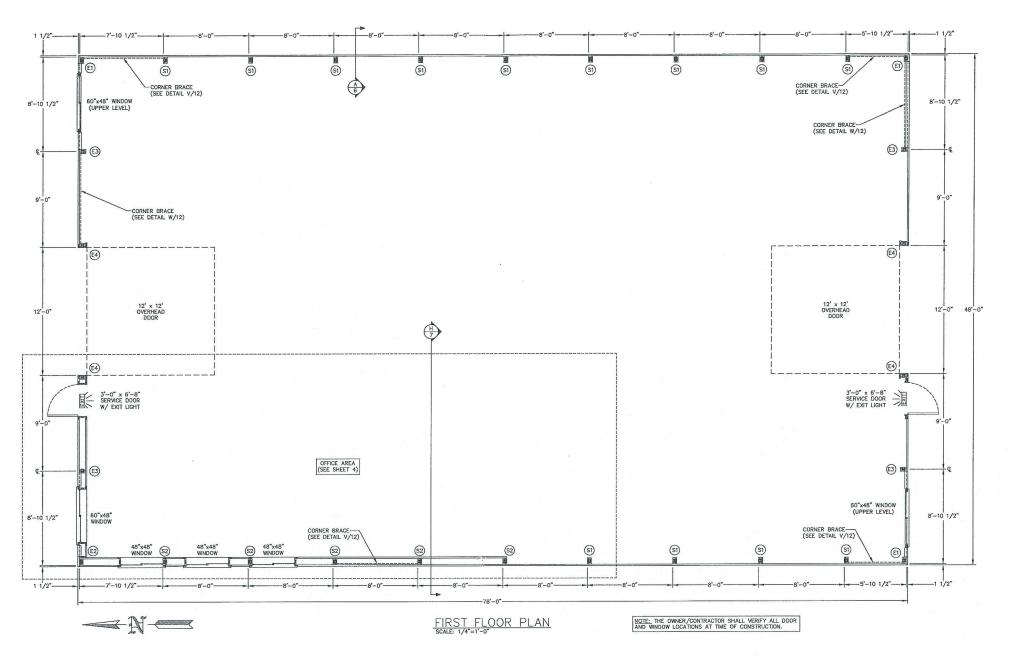


COLUMN, FOOTING & BRACKET SCHEDULE								
COLUMN LOCATION	COLUMN DESCRIPTION	EMBEDMENT	NUMBER OF COLUMNS	⚠ FOOTING DESCRIPTION	BRACKET DESCRIPTION	NO.OF BRACKETS PER COLUMN	BRACKET TO COLUMN	BRACKET TO CONCRETE (EACH COLUMN)
S1	3-PLY (18')-2x8 2400f MSR SYP LAMINATED COLUMN	0'-0"	13	8" FROST WALL (SEE DETAIL B/6)	SWP83		(2)-1/2"øx6" BOLTS & (8)-1/4"x3" WOOD SCREWS	N/A
S2	3-PLY (18')-2x8 2400f MSR SYP LAMINATED COLUMN	0'-0"	5	8" FROST WALL (SEE DETAIL J/7)	SWP83	1	(2)-1/2"øx6" BOLTS & (8)-1/4"x3" WOOD SCREWS	N/A
E1	3-PLY (18')-2x8 2400f MSR SYP LAMINATED COLUMN	0'-0"	3	8" FROST WALL (SEE DETAIL B/6)	PA80	1	(2)-1/2"øx4" LAG SCREWS & (8)-1/4"x3" WOOD SCREWS	(1)-5/8"øx5" WEDGE BOLT, 4-3/4" MIN. EMBEDMER
E2	3-PLY (18')-2x8 2400f MSR SYP LAMINATED COLUMN	0'-0"	1	8" FROST WALL (SEE DETAIL J/7)	PA80		(2)-1/2"øx4" LAG SCREWS & (8)-1/4"x3" WOOD SCREWS	(1)-5/8"¢x5" WEDGE BOLT, 4-3/4" MIN. EMBEDMEN
E3	3-PLY (22')-2x8 2400f MSR SYP LAMINATED COLUMN	0'-0"	4	8" FROST WALL (SEE DETAIL B/6)	SWP83	1	(2)-1/2"øx6" BOLTS & (8)-1/4"x3" WOOD SCREWS	N/A
E4	3-PLY (24')-2x8 2400f MSR SYP LAMINATED COLUMN	0'-0"	4	8" FROST WALL (SEE DETAIL B/6)	PA80	1	(2)-1/2"øx4" LAG SCREWS & (8)-1/4"x3" WOOD SCREWS	(1)-5/8"øx5" WEDGE BOLT, 4-3/4" MIN. EMBEDMEN


	IAA AA	P
	MATINA	
	ENGINEERING SERVICES)	S
100	5311 KANE RD. EAU CLAIRE, WI 54703 (715) 876-5555	

PROJECT TITL	E:
DOC	THOMPSON PLUMBING
SHEET TITLE:	FIRST FLOOR PLAN AND

0.00	[21]	10/08/12	ADD	8	FROST	WALL	T.M.G	FLE
GAHANNA, OH	2							
TITLE: FIRST FLOOR PLAN AND	3							DR.
COLUMN, FOOTING & BRACKET SCHEDULE	4			-000				K

		REVISIONS		PROFESSIONAL ENGINEER:		SHEET NO.
NO.	DATE	DESCRIPTION	BY	JEFF MURRAY	W291120H03	0
A	10/06/12	ADD 8" FROST WALL	T.M.G	PLAN DESIGNER:	DATE:	. 1
2		7 7 7 7 7 7 7 7 7 7 7 7 7 7 7 7 7 7 7 7		LOUISE EWALD	09-18-2012	
3				DRAWN BY:	SCALE:	OF 1
4				KEITH SCHEUNEMANN	AS NOTED	01 /

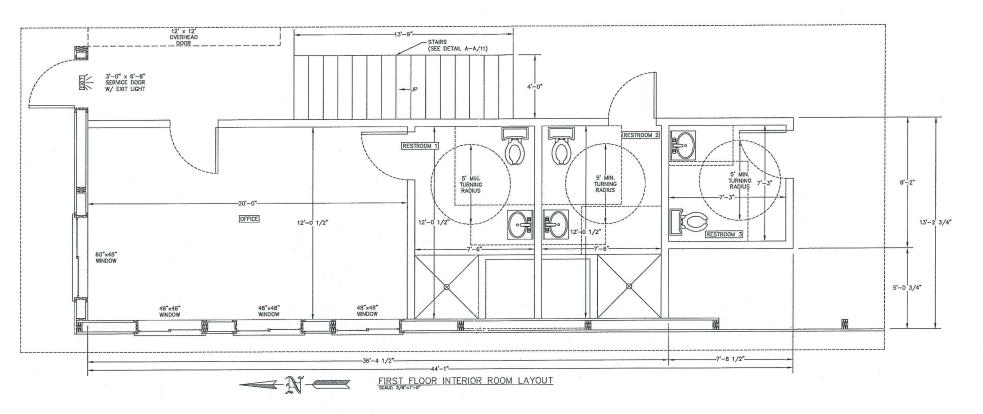

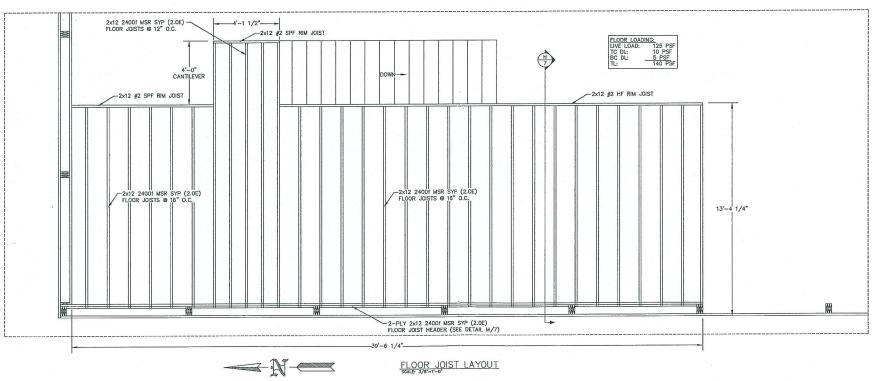




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DOC	THOMPSON	PLUMBING
	GAHANNA, O	H

	REVISIONS				PROFESSIONAL ENGINEER:			
MBING	NO.	DATE	DESCRIPTION	BY	JEFF MURRAY	W291120H04		
	1				PLAN DESIGNER:	DATE:	1	
	2				LOUISE EWALD	09-18-2012		
	3				DRAWN BY:	SCALE:	1	
OIST LAYOUT	4				KEITH SCHEUNEMANN	AS NOTED		

OF 14

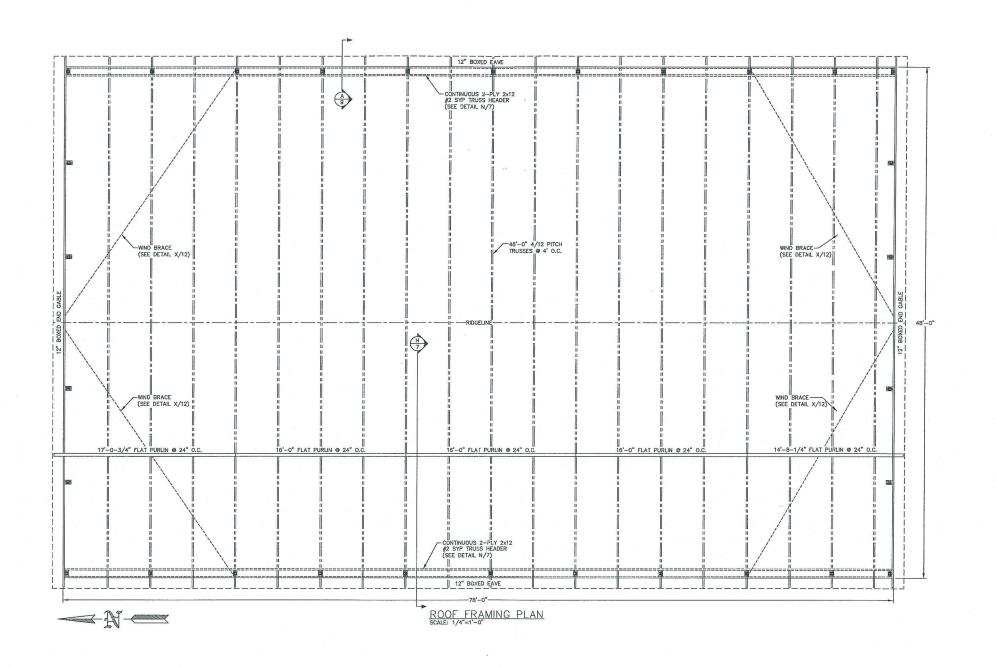






DOC	THOMPSON	PLUMBING
	GAHANNA, O	H


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		GZ	AHANNA, OH		5 5	2	Γ
SHEET	TITLE:					3	Γ
		ROOF	FRAMING P	LAN		4	
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		REVISIONS		PROFESSIONAL ENGINEER:		SHEET
NO.	DATE	DESCRIPTION	BY	JEFF MURRAY	W291120H05	,
1				PLAN DESIGNER:	DATE:	1 1
2				LOUISE EWALD	09-18-2012	-
3				DRAWN BY:	SCALE:	OF
4				KEITH SCHEUNEMANN	AS NOTED	01



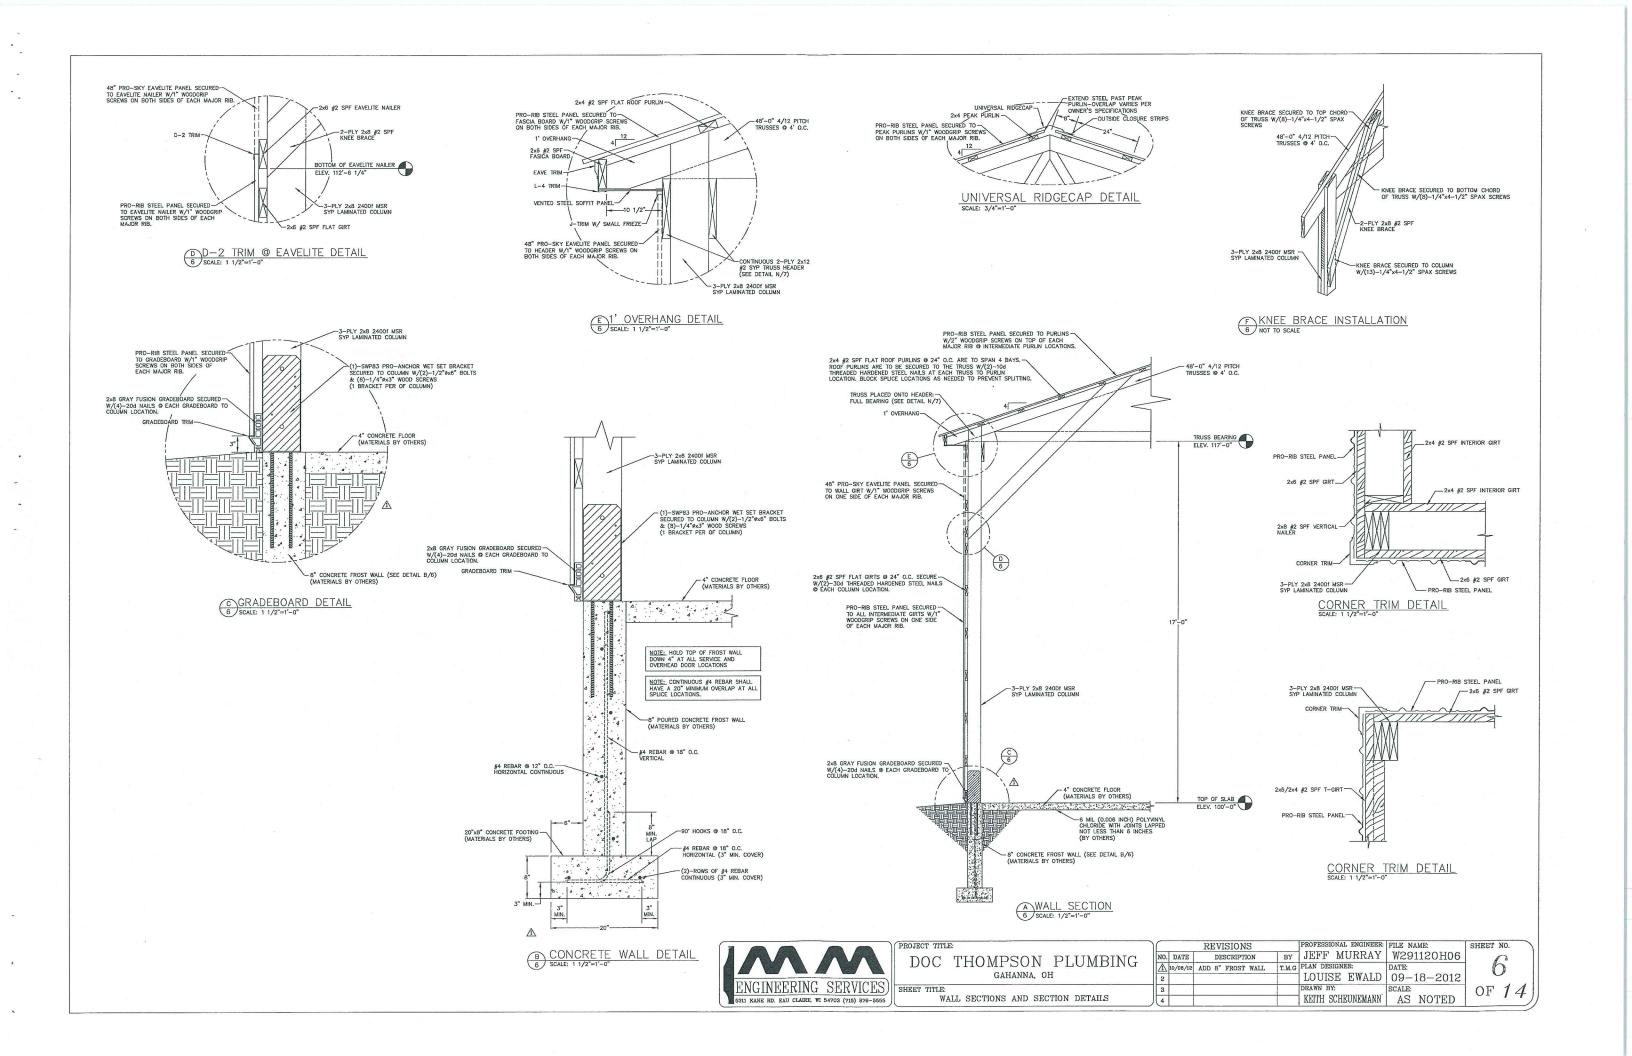


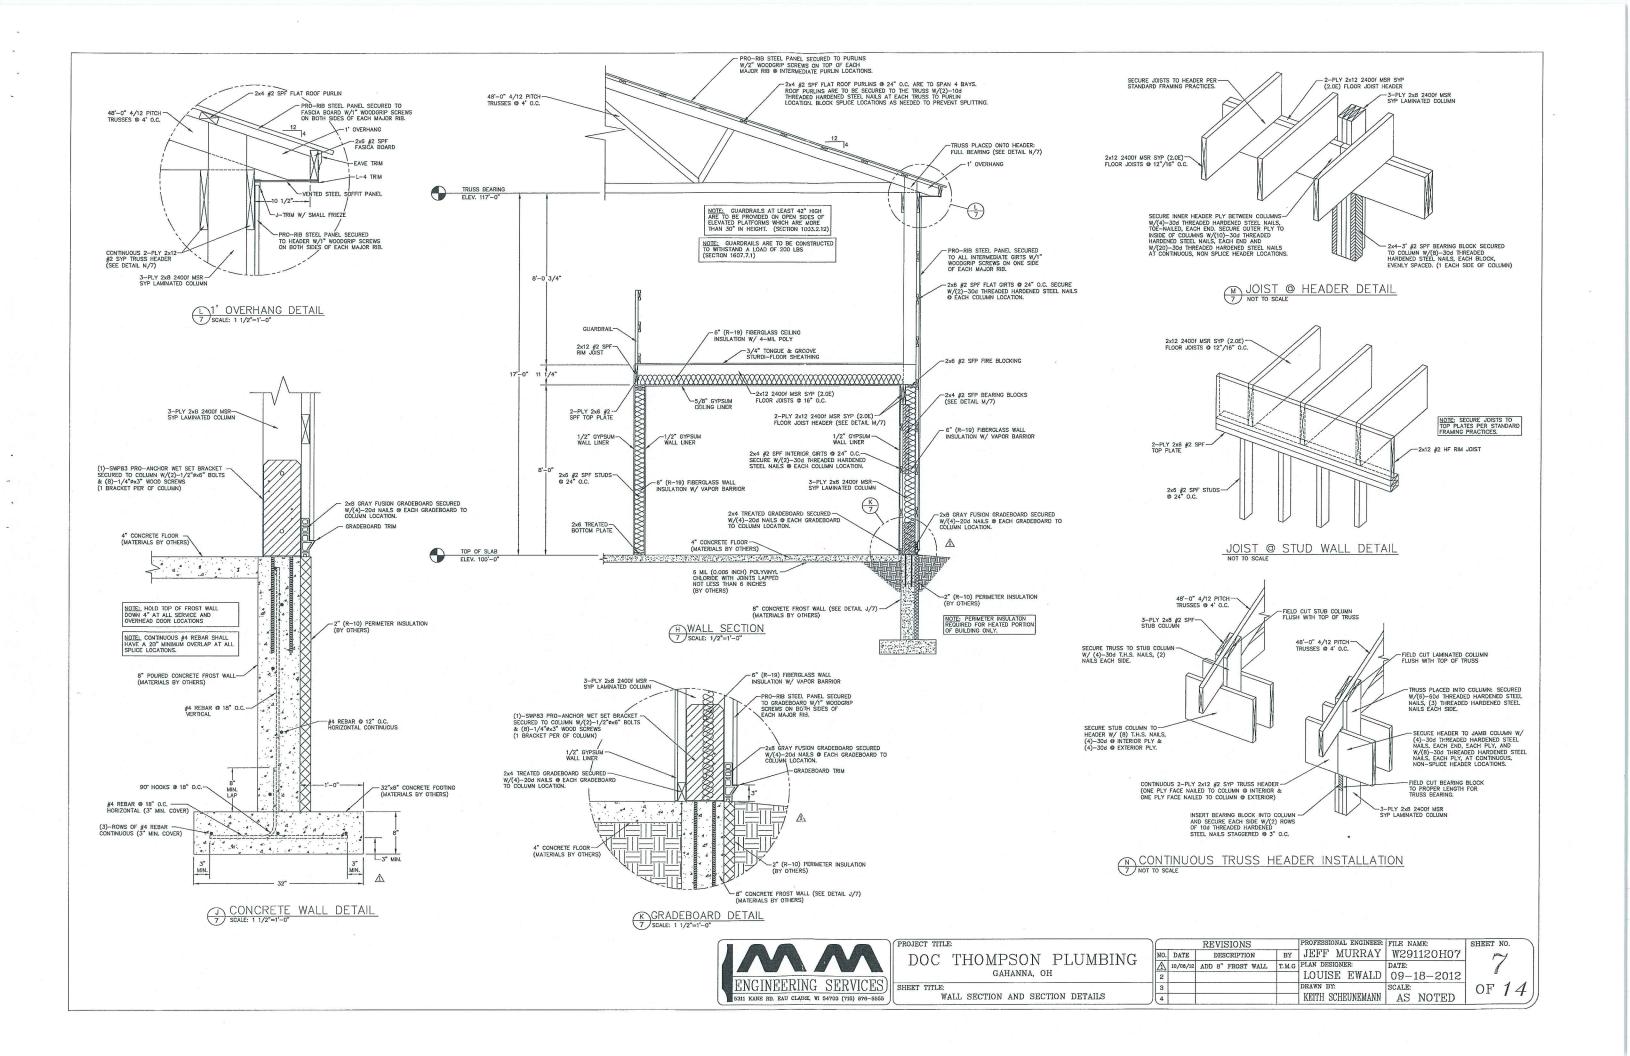

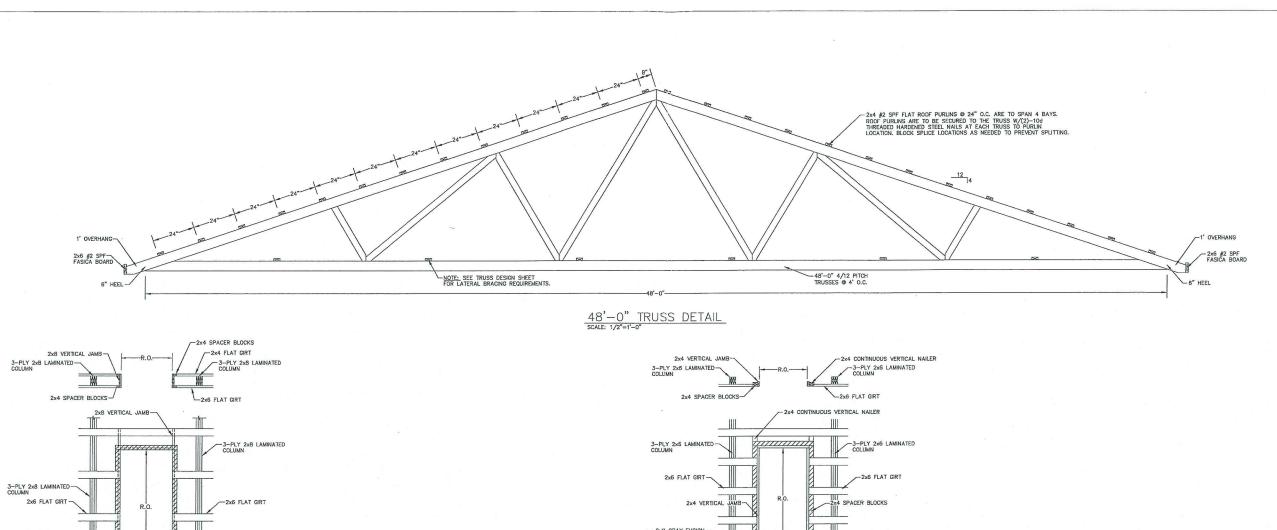

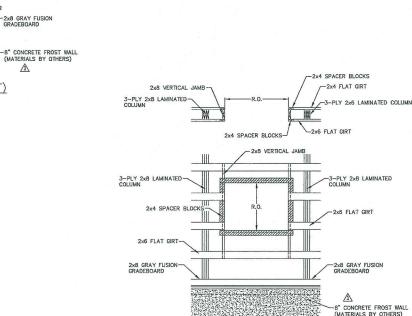WINDOW FRAMING (DOUBLE GIRTS) SCALE: 3/8"=1"-0"

DOOR FRAMING (DOUBLE GIRT)
SCALE: 3/8"=1'-0"

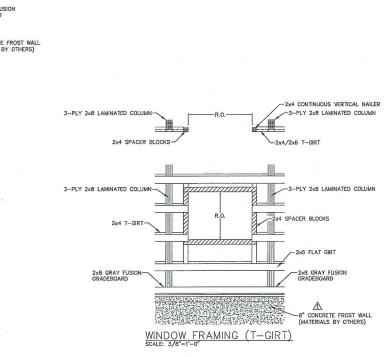






ROJECT TITLE	3:
DOC	THOMPSON PLUMBING
	GAHANNA, OH
HEET TITLE:	AND MISCELLANEOUS FRAMING DETAILS


DOOR FRAMING (FLAT GIRT)
SCALE: 3/8"=1"-0"


		REVISIONS		PROFESSIONAL ENGINEER:		SHEET NO.
NO.	DATE	DESCRIPTION	BY	JEFF MURRAY	W291120H08	
A	10/08/12	ADD 8" FROST WALL	T.M.G	PLAN DESIGNER:	DATE:	
2				LOUISE EWALD	09-18-2012	
3				DRAWN BY:	SCALE:	OF 14
4				KEITH SCHEUNEMANN	AS NOTED	01 17

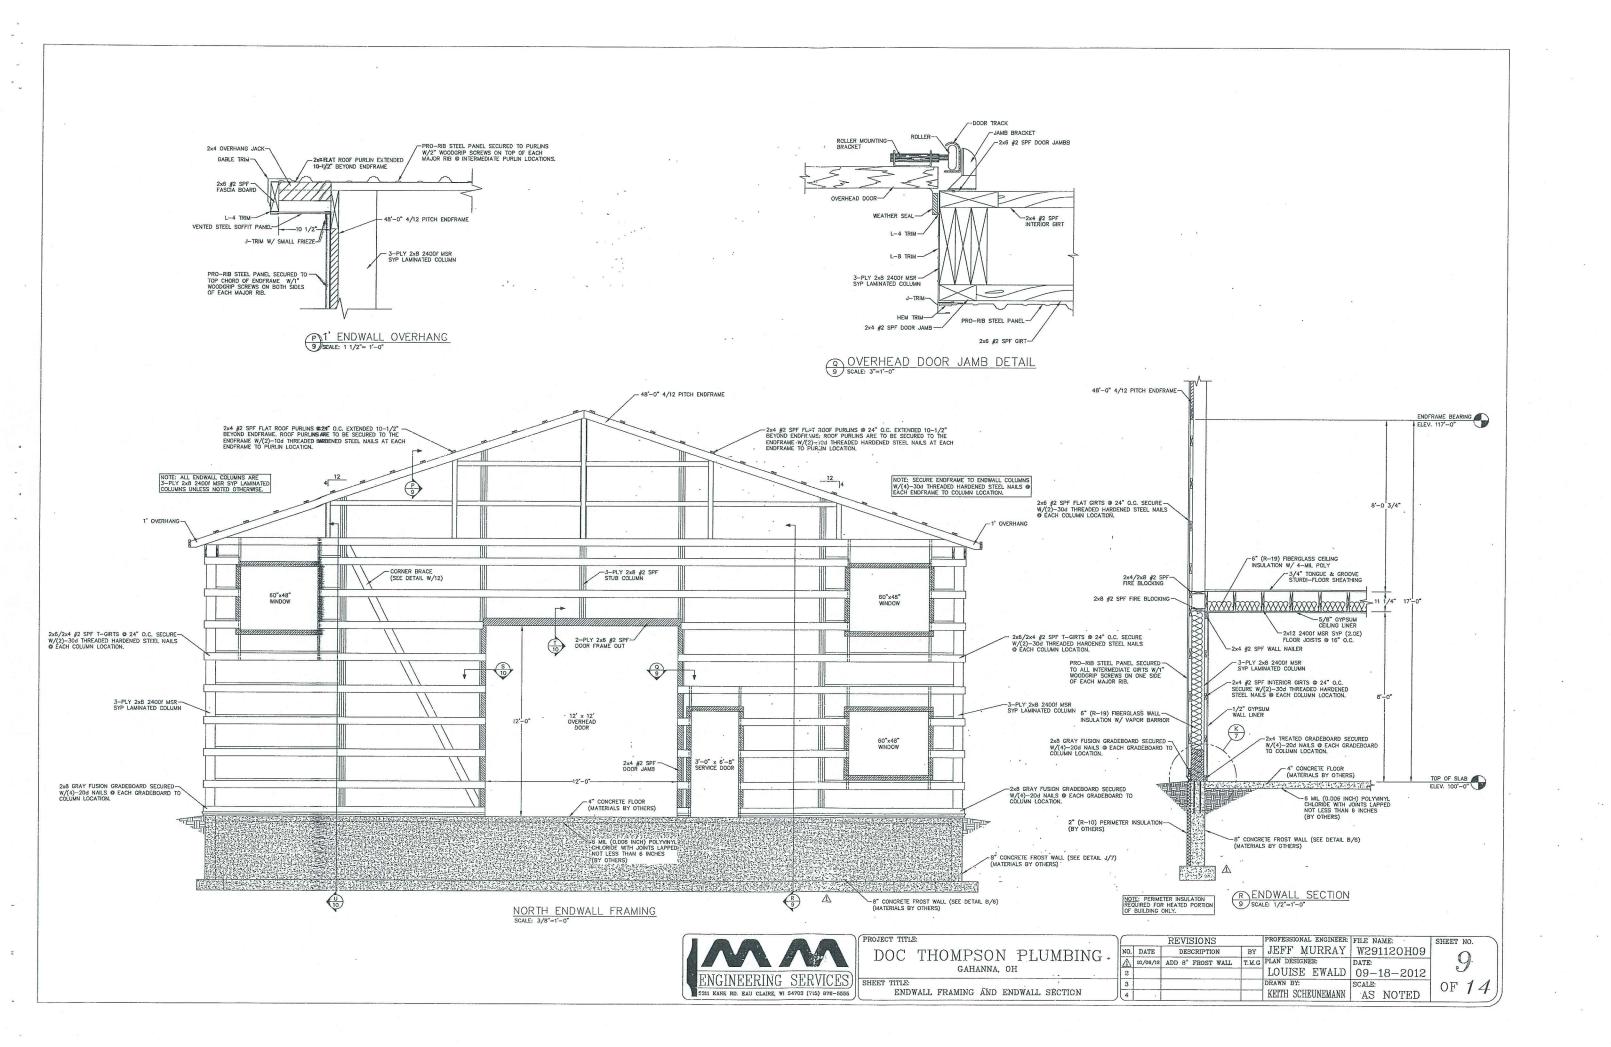


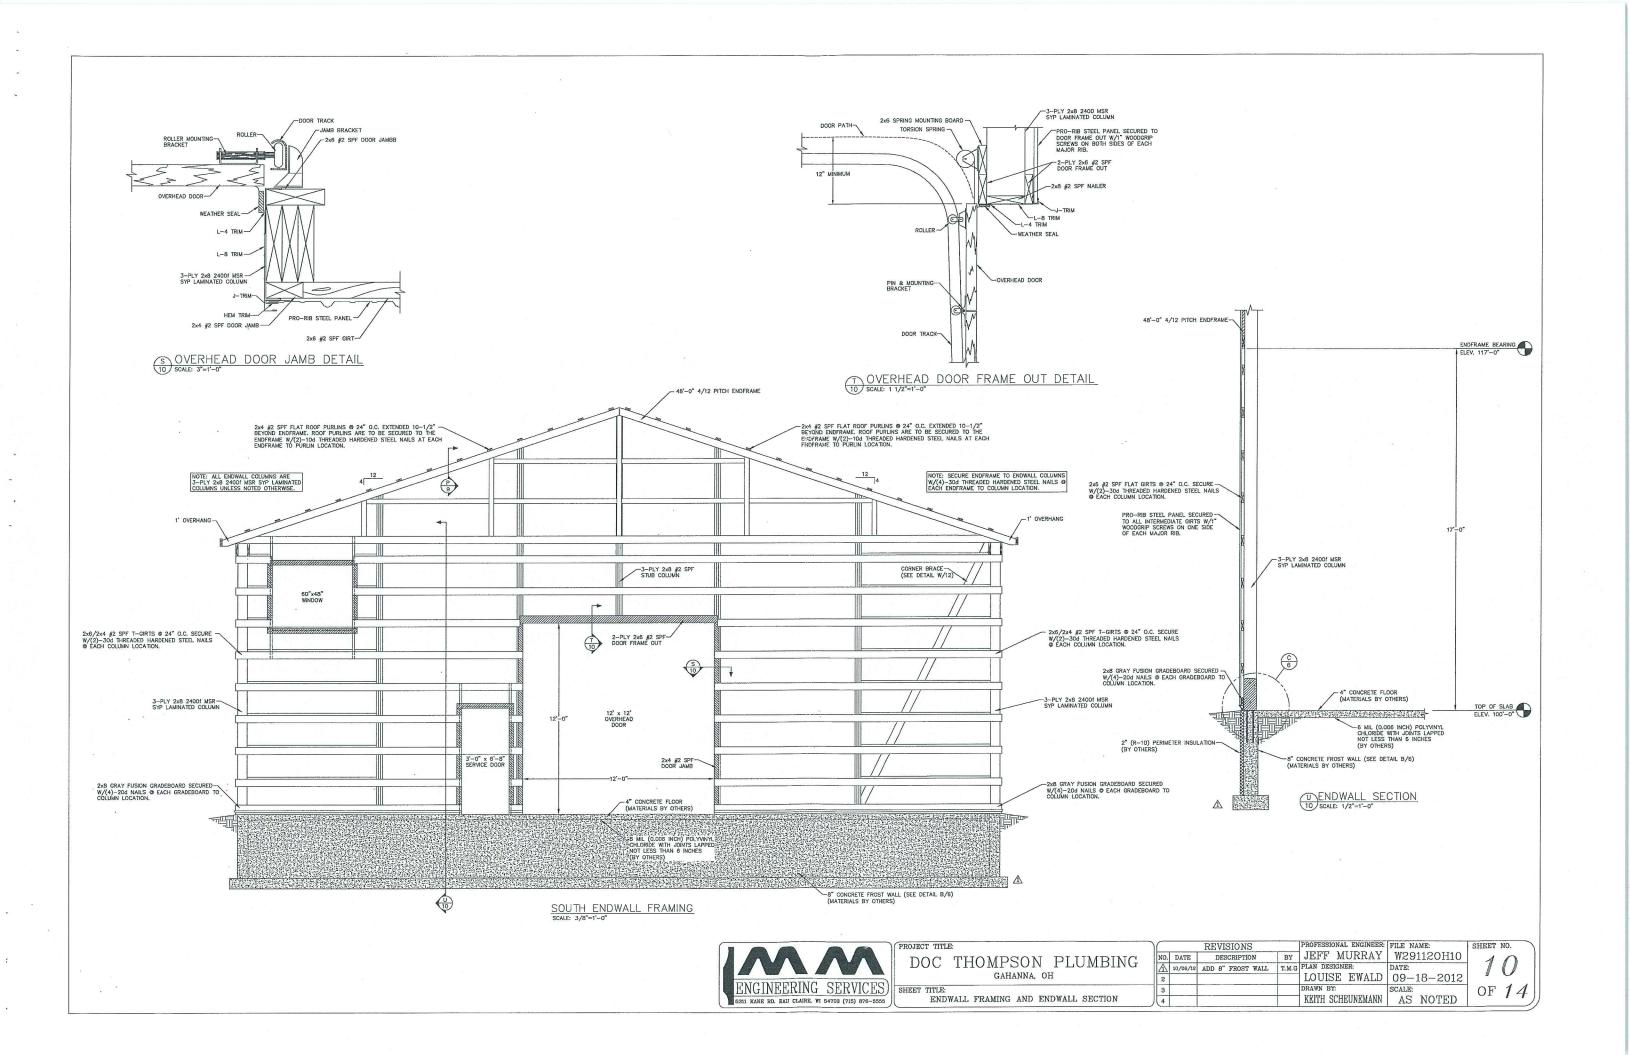

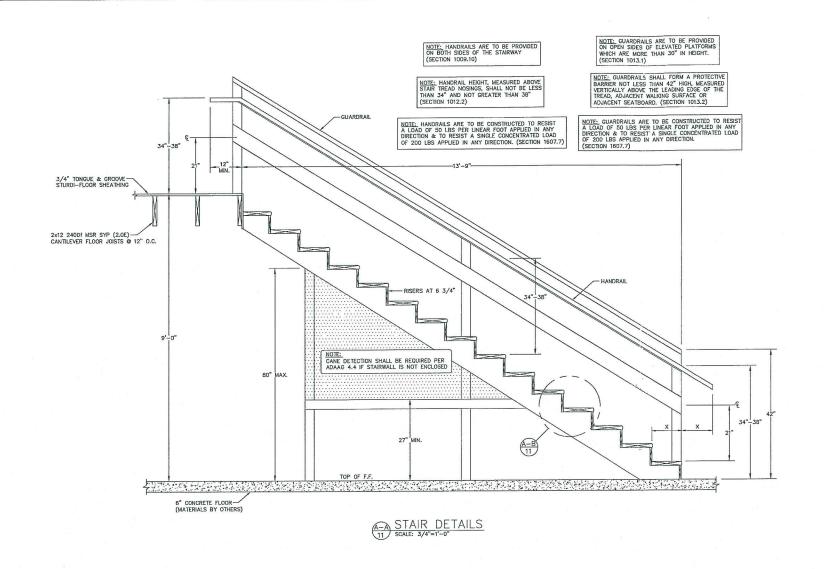

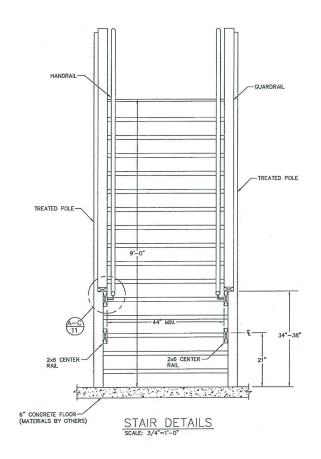


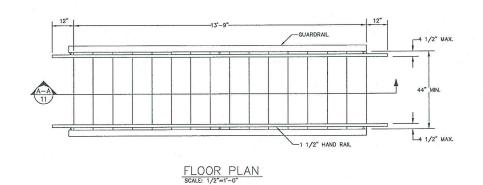

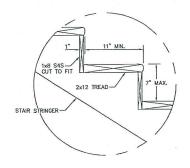

A-B TREATED & RISER DETAIL

11 SCALE: 1 1/2"=1"-0"

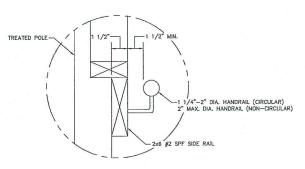

PROFESSIONAL ENGINEER: FILE NAME:

SHEET NO.


of 14

HANDRAIL DETAIL





JECT TILL	E:	
DOC	THOMPSON	PLUMBING
	GAHANNA, O	H

		REVISIONS				5
NO.	DATE	DESCRIPTION	BY	JEFF MURRAY	W291120H11	
1			-			
2				LOUISE EWALD	09-18-2012	
3	-			DRAWN BY:	SCALE:	
4				KEITH SCHEUNEMANN	AS NOTED	
	NO. 1 2 3 4	NO. DATE 1 2 3 4			NO. DATE DESCRIPTION BY JEFF MURRAY	NO. DATE DESCRIPTION BY JEFF MURRAY W291120H11

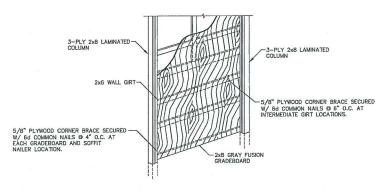

V CORNER BRACE
12 NOT TO SCALE

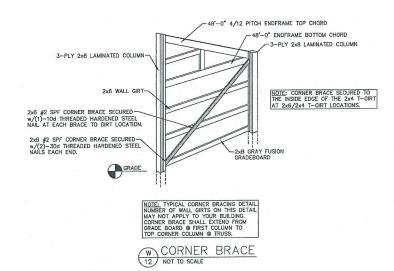

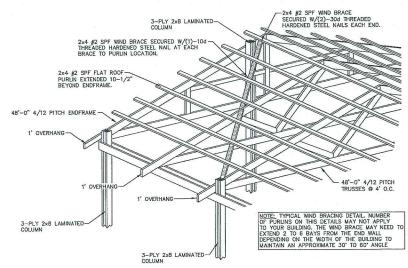

X WIND BRACE 12 NOT TO SCALE


STEEL PANEL INSTALLATION GENERAL NOTES:


PROPER LAPPING OF STEEL PANEL IS VERY IMPORTANT IN THE PANEL'S ABILITY TO PREVENT LEAKING. OVERSEATING AND UNDERSEATING OF LAP IS NOT PERMITTED.


2) FASTENER TIGHTNESS IS CRITICAL IN THE LONGEVITY OF THE FASTENER'S ABILITY TO HELP PREVENT LEAKS AND STRUCTURAL LOAD CARRYING CAPACITY, OVER—TORQUING OF SCREWS WILL REDUCE THE SCREW'S WITHDRAWAL CAPACITY, REGRADIESS OF THE CONSTRUCTION MATERIALS INVOLVED. UNDER—TORQUING OF SCREWS WILL INCREASE THE POTENTIAL OF ROOF LEAKS.


3) FASTENER LOCATION IS CRITICAL FOR INSTALLERS TO MINIMIZE THE POTENTIAL OF OIL CANNING, DIMPLES, AND OTHER APPEARANCE RELATED ISSUES.

4) THE ANTI-SYPHON DRAIN CHANNEL MUST BE CLEAR OF DEBRIS AND OBSTRUCTIONS FOR THE PANEL'S ABILITY TO MINIMIZE THE POTENTIAL OF CAPILLARY ACTION OF WATER FROM GETTING UNDER THE STEEL PANEL.

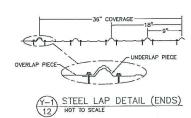


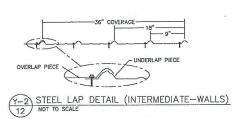


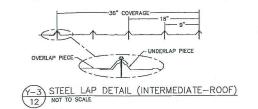

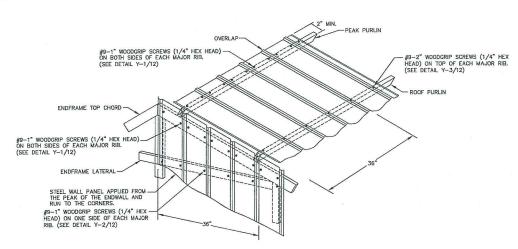

ROOF & ENDWALL STEEL APPLICATION @ GABLE PEAK & INTERMEDIATE

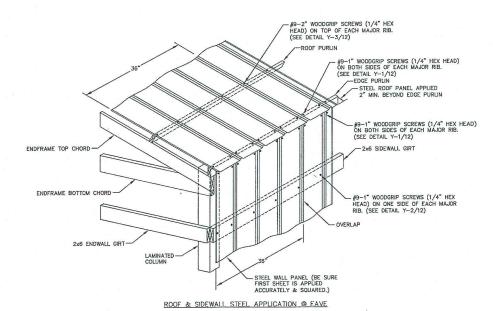

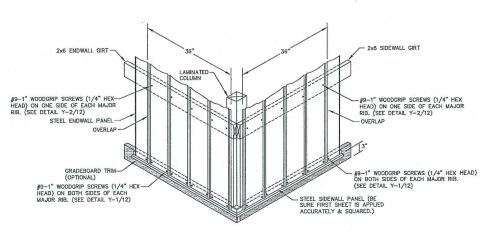

WALL STEEL APPLICATION @ GRADEBOARD


STEEL APPLICATION DETAILS





ROJECT TITL	E:	
DOC	THOMPSON	
	GAHANNA, O	H


TTTLE:	11			
C THOMPSON PLUMBING	NO.	DESCRIPTION	BY	JEF
	1			PLAN I
GAHANNA, OH	2			LOU
PITLE:	3			DRAWN
MISCELLANEOUS FRAMING AND STEEL DETAILS	4			KEITH

	REVISIONS		PROFESSIONAL ENGINEER:	Control of the second of the s	SHEET	NO.
	DESCRIPTION	BY	JEFF MURRAY	W291120H12	A	60
			PLAN DESIGNER:	DATE:		1
		1	LOUISE EWALD	09-18-2012	Ш	
			DRAWN BY:	SCALE:	OF	1.
1			KEITH SCHEUNEMANN	AS NOTED	0.1	,

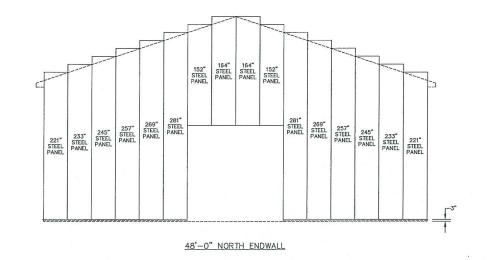

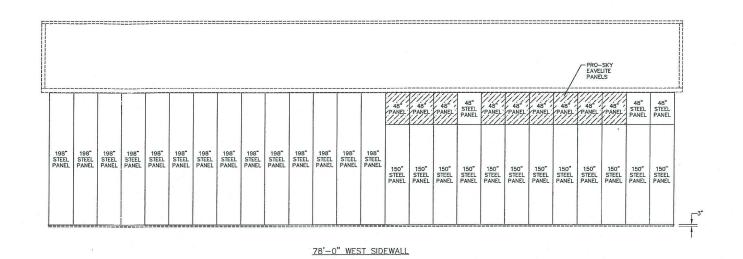

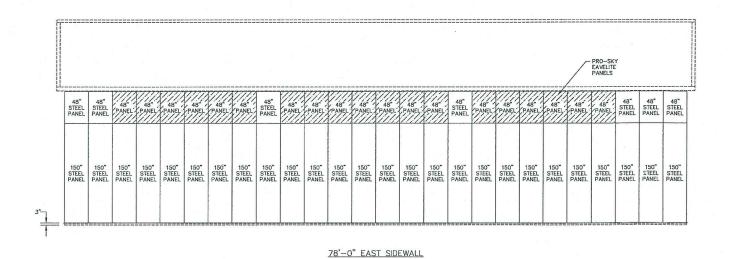

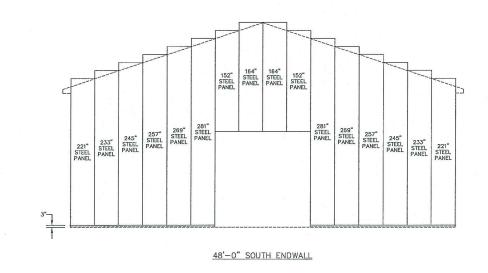


STEEL LAYOUTS



ROJECT TITL	E:	
DOC	THOMPSON GAHANNA, O	
HEET TITLE:	STEEL LAYOU	

\bigcap		REVISIONS		PROFESSIONAL ENGINEER:		SHEET NO.
NO.	DATE	DESCRIPTION	BY	JEFF MURRAY	W291120H13	10
1				PLAN DESIGNER:	DATE:	1 / . 3
2				LOUISE EWALD	09-18-2012	
3				DRAWN BY:	SCALE:	OF 11
4				KEITH SCHEUNEMANN	AS NOTED	01 7 7

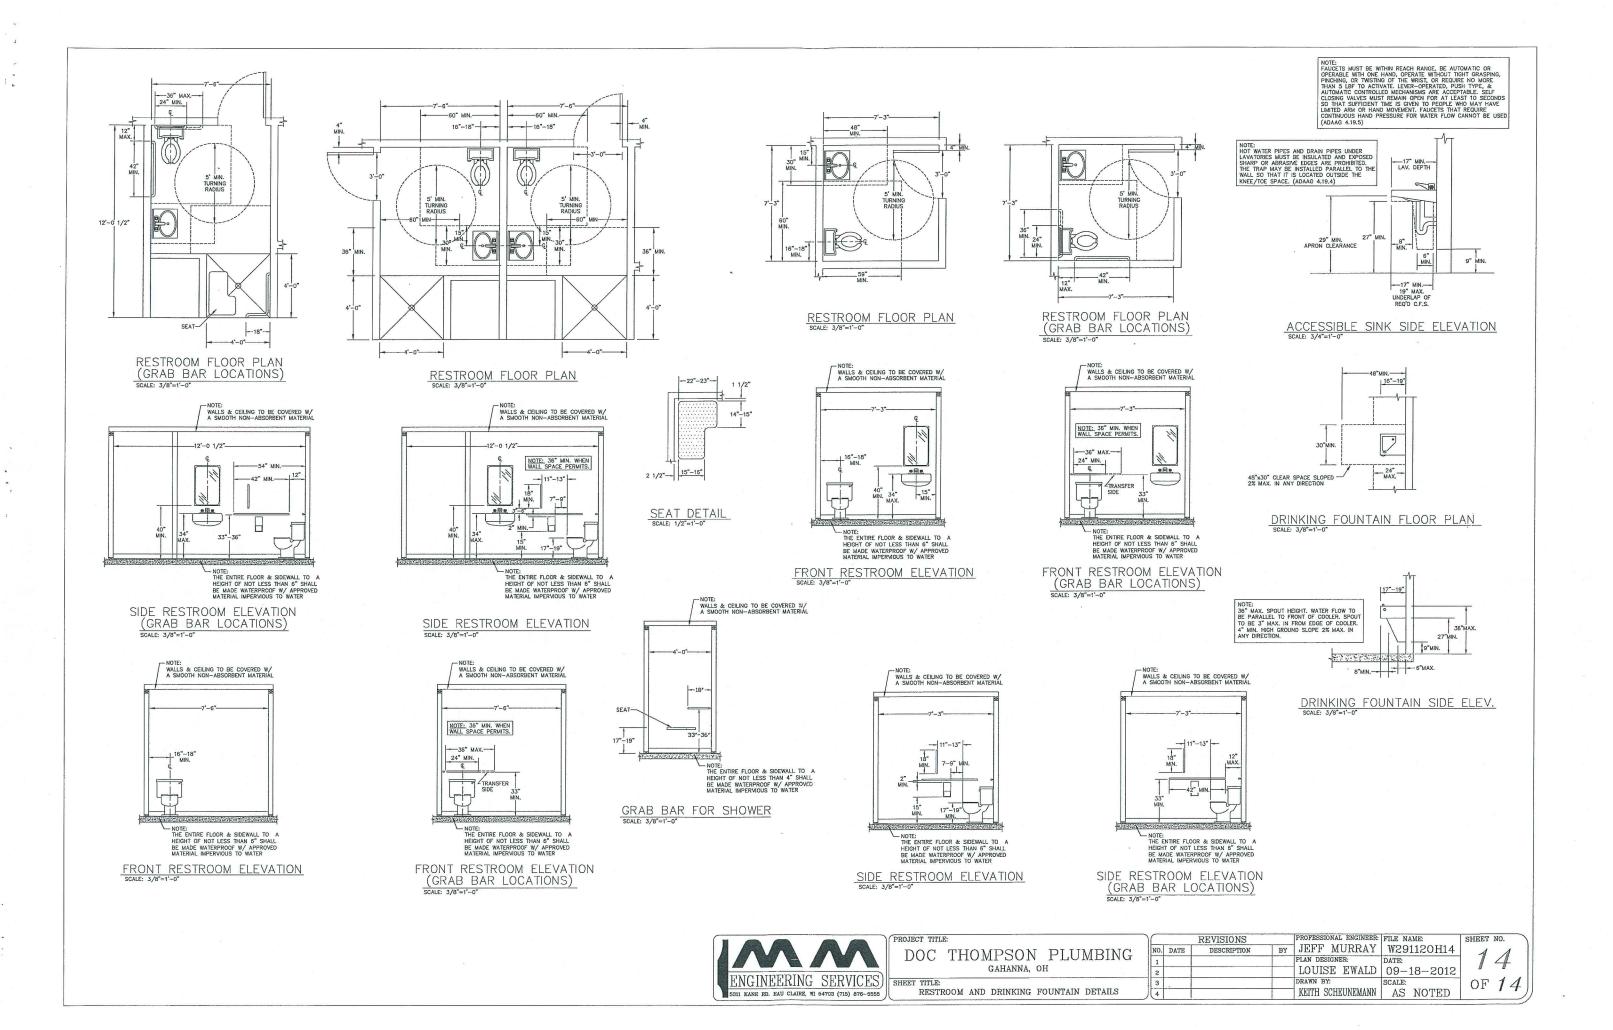

File No. DZ-Z-ZOJ3
Supersedes File No.(s) _____
Scheduled Public Hearing Date: ____

Fee: 87, 50 or none

Check or Receipt#: 16087
Initials: CAS
Date Received 12-11-12

APPLICATION FOR CERTIFICATE OF APPROPRIATENESS DESIGN REVIEW CITY OF GAHANNA PLANNING COMMISSION

Site Address 1601 Eastgate Parkway Zor	ning District 6CT Parcel ID# 625-012947
*Business Name Doc Thompson Runbing	Phone (644) 855-2923
Business Address 1120 Venetian Way	Fax
City/State/Zip Gahanna, 64 43230	
Owner/Representative David Thompson	Title President
Address 1/20 Venetian Way	Phone (614) 855-2923
City/State/Zip Gahanna. 04 43230	
Designer Architect Engineer En447 - Craig Bohning	City License No:
Address 5500 New Altany Road	Phone (6/4) 775-4400
City/ State/ Zin Calumbus, OH 43054	Fax (614) 775-4800
Representative Craig Bohning	Title Vice President
Design Review of: Site Plan Landscaping	Building Design Signage
Special Information Regarding the Property and its Proposed	
opolic mismanon regulating the reporty and the re-	
Submission Requ	<u>irements</u>
 (2) Fee: \$50.00 for review plus \$.01per square foot. (3) Ten (10) copies of the plans are to be folded (NOT ROLLI (4) Submit reduced drawing suitable to an 8 1/2 x 11 inch size (5) Submit one (1) color rendering of the project in plan/ pers foam core, gator board or other acceptable material. (6) Submit a detailed list of materials. *Note: This application will not officially be accepted until <u>all</u> *Note: Planning Commission members and/or City Staff may application. 	e. spective/ or elevation, mounted on 18 x 24 inch size items listed above have been received.
Applicant's Signature	Date
APPROVA	L
In accordance with Sections 1197.05 of the Codified Ordinal stated above, has been approved by the Gahanna Planning comply with any conditions approved by the Commission regulations now in force.	nces of Gahanna, this certifies that this project, as Commission on 4/3/2. The applicant shall
Conditions:	
Bynnie Gard	3/18/13
Planning & Zoning Administrator	Date'
Note: All correspondence will be to applicant above unless otherwise stated.	DEC 1 1 2012 DEC 1 1 2012

*		
File No Supersedes File No.(s)	Fee:or none	Check or Receipt#: Initials:
Scheduled Public Hearing Date:		Date Received
Site Address // Site Address Name DAVID St. Business Address //2018	DESIGN REVIEW OF GAHANNA PLANNING ATE ARK WIY Zoning THOMPSON BE NETINN WAY	G COMMISSION District Parcel ID# Phone 614 833-292 = Fax Sarge
		Tillo
		Title
		Phone
Denistrate/Zip	E 19 LL AUT	FaxCity License No:
Address Me us As 22	Political Ro	Phone 995: 4500
City State 7 in Con 5	MH.	Fax
		Title <u>L'AGIN EES</u>
		Building Design _//_ Signage _//
- ADIO	Submission Requiren	nents
(4) Submit reduced drawing suitable (5) Submit one (1) color rendering of cam core, gator board or other acc (6) Submit a detailed list of material (Note: This application will not office)	Iper square foot, to be folded (NOT ROLLED) e to an 8 1/2 x 11 inch size. of the project in plan/ perspect ceptable material. ls. cially be accepted until <u>all</u> item	to 8 1/2 x 11 inch size prior to submission. tive/ or elevation, mounted on 18 x 24 inch size as listed above have been received.
application.	bers and/or City Stair may visi	it the property prior to the hearing to review the
Wantel R Wan	Man	DEC: 11,12
Applicant's Signature		<i>Disc.</i> 11, 12 Date
	APPROVAL	
tated above, has been approved b	D5 of the Codified Ordinances by the Gahanna Planning Cor	s of Gahanna, this certifies that this project, as mmission on The applicant shall distance and shall comply with all building and zoning
Conditions:		
		•

Planning & Zoning Administrator

Date

Note: All correspondence will be to applicant above unless otherwise stated.

Revised February 2009


SUBMITTAL REQUIREMENTS


		Applicant Or Agent	Planning & Zoning Administrator
I. GER	NERAL REQUIREMENTS		
A.	All exhibits required for the permanent file (noted in the following paragraphs) must be able to be reduced to "legal size" (81/2" x 14) by folding, photo reduction, etc. (ALL PLANS ARE TO BE FOLDED BY APPLICANT PRIOR TO SUBMISSION.) While large mounting boards, material samples, or other exhibits not meeting this criteria maybe used for Planning Commission presentation, the Commission does appreciate the use of the audio visual system whenever possible	A	
В.	Ten black or blue-line prints of the plans including the items listed in sections II & III shall be submitted to the Planning & Zoning Administrator for presentation to the Commission.	В	
C.	An adequate number of color photographs (Polaroid-type acceptable) are required to illustrate the site, including buildings and other existing features as well as adjacent properties. Photos may also be used to illustrate installations on other sites that are similar to the applicant's proposal.	C	
	Materials List ILDING CONSTRUCTION, EXTERIOR REMODELING, AND ADDITIONS UDING PARKING LOTS AND LANDSCAPING)	D	
Α.	Site Plan. A site plan is required containing the following information: 1. Scale and north arrow, 2. Project name and site address; 3. All property and street pavement lines; 4. Existing and proposed contours; 5. Gross area of tract stated in square feet; 6. Proposed ingress and egress to the site, including on site parking area(s), parking stalls and adjacent streets. Delineate traffic flow with directional arrows and indicate the location of direction signs or other	1. \[\frac{\sqrt{2}}{2} \\ \frac{\sqrt{2}}{3} \\ \frac{\sqrt{2}}{4} \\ \frac{\sqrt{2}}{5} \\ \frac{\sqrt{2}}{3} \\ \frac{\sqrt{2}}	
	motorist's aids (if any); 7. The designation of required buffer screens (if any) between the parking area and adjacent property; 8. Location of all isolated existing trees having a diameter of six (6) inches or more; (Tree masses may be shown with a diagrammatic outline and a written inventory of individual trees exceeding 6" in caliber); 9. Existing landscaping that will be retained and proposed landscaping shall be differentiated and shown on the plan. The type, size, number, and spacing of all plantings and other landscape features must be illustrated;	7NA 8/ 9/	
	10. Identify photograph location; 11. Location of all existing and proposed building on the site 12. Location of all existing (to remain) and proposed lighting standards.	10. / 11. / 12.	
	 13. Provide breakdown of parking spaces required and spaces provided (see COG 1163); 14. Provide interior landscaping breakdown for paved surface (5% of paved surface required to be landscaped with one (1) tree per 100 square feet, see COG 1163) 	13. ✓	
	15. Provide lot coverage breakdown of building and paved surface areas.	15. 🗸	

В.	Elevations. Complete elevation from all sides of all proposed construction labeled North, South, East and West and related elevations of existing structures (if any) are required containing the following information: 1. Scale; 2. Changes in ground elevation; 3. All signs to be mounted on the elevations; 4. Designation of the kind, color, and texture of all primary materials to be used; 5. Fenestration, doorways, and all other projecting and receding elements of the building exterior.	1.	7
C.	Optional requirements at discretion of Planning Commission. 1. Scale model. 2. Section Profiles. 3. Perspective drawing.	1 2 3	
D.	Material Samples. Material samples are required for all exterior materials. For presentation purposes, a narrative description is required for Planning Commission file.	D	
A.	Lighting Standard Drawing. A scaled drawing of the proposed lighting standard(s) is required and should contain the following information: 1. All size specifications; 2. Information on lighting intensity (number of watts, isofootcandle diagram, etc., at least 1/2 foot candles required); 3. Materials, colors, and manufacturer's cut sheet; 4. Ground or wall anchorage details. Lighting to be wall mounted lights.	1 2 3 4	

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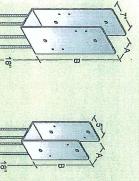




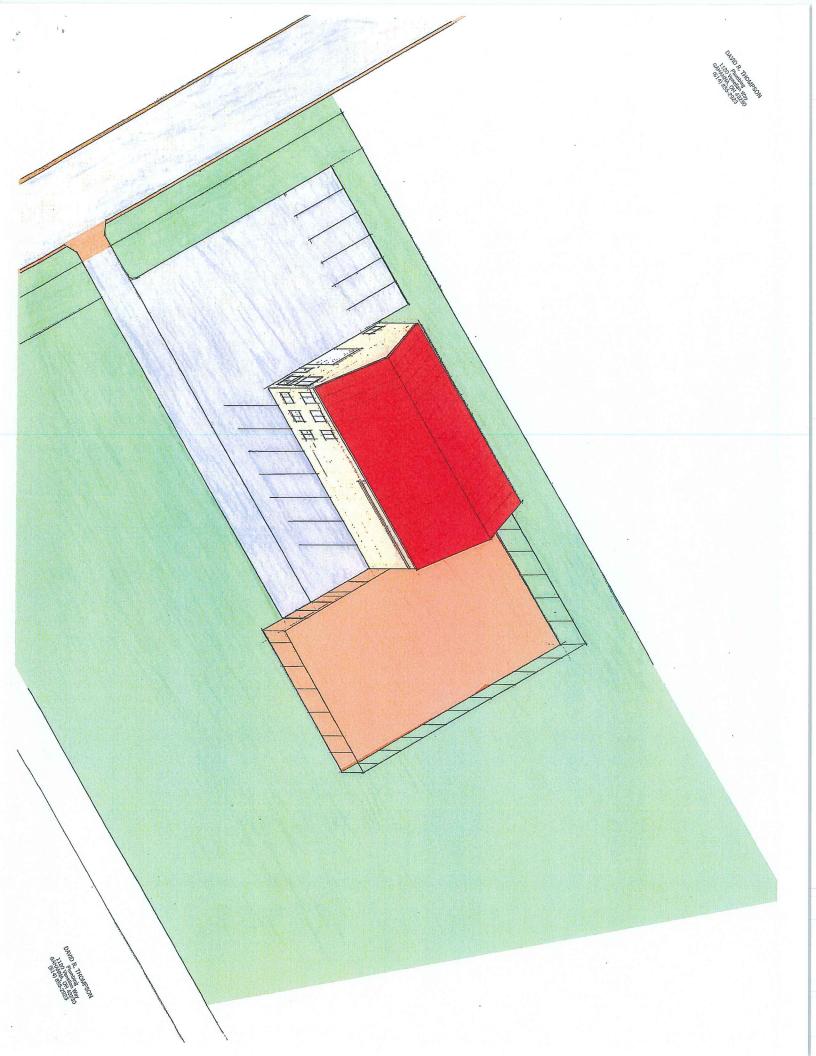

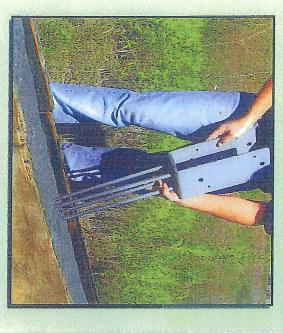- Wet setting eliminates time consuming masonry drilling.
- Strongest connection to concrete possible.
- nardware. Includes wood to bracket connecting


MELSEL WODER



	245		L. W.			T allo
110-4991	110-4987	110-4983	110-4979	110-4975	110-4971	SKU#
110-4991 4 PLY 8" LAM COL 6-1/8" 18"	3 PLY 8" LAM COL 4-5/8"	6" X 6" POST	10-4979 4 PLY 6" LAM COL 6-1/8"	10-4975 3 PLY 6" LAM COL 4-5/8"	4" X 6" POST	TYPE
6-1/8"	4-5/8"	5-5/8"	6-1/8"	4-5/8"	3-5/8"	DIM A
18"	18"	13"	18"	13"	13"	DIM A DIM B
9,138	9,138	6,638	6,638	6,638	6,561	SHEAR (lbs)
11,519	11,519	9,019	9,019	9,019	9,019	UPLIFT (lbs)
59,000	59,000	28,000	28,000	28,000	28,000	MOMENT (in-lbs)

an englineered product, it's not just glide and

portion that will contact the ground, we use (g) restrict pipolicicition.

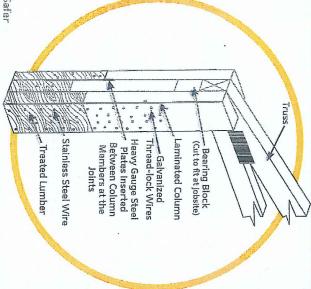

Our column's pre-built notchallows trusses to fit firmly in the column. This eliminates the need to carry a chain saw up a ladder to notch the timber.

Stronger

be the weakest point. Our columns use a 20 gauge stainless steel plate at all splice points in the column. This provides maximum strength even at what would normally

It is manufactured.

We use a hydraulic pressure system that generates hundreds of pounds of pressure over the entire length of the column, straightening it before

We can build columns up to 60' or greater. Try getting a 6x6x60' from your local lumber yard! We also provide multiple lumber grades so your columns are built for your application, not overbuilt or overpriced. More Versatile

Engineering and Design

Let Us Design Your Building

Manufacturing Engineering is dedicated to will put their experience to work for you. Midwest are becoming more complicated. These specialty economical building without sacrificing quality. knowledge. Our licensed, professional engineers buildings require more than just general building In today's hi-tech world, buildings and structures providing you with the best designed, most

snow loads? Do you need to provide documents signed off by an Engineer (Engineering Seal)? MM Engineering can help! Does your project need to meet specific wind or

For post frame estimates and questions,

ryggeriasi išvillėting "Tights Street granting Treets

Design-It® Center

with Easy To Use Touch Screens

Computerized

Steam Booking Panel Layoute for Easy installation

and use the convenier

MENARDS

Design-It® Center

to get a quote in minutes!

Siberel (Keorogianie)



WENT OF LAND

西河河 Design & Estimate our beliding projects he



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POST FRAME BUILDINGS



Commercial

Suburban

Agricultural



offers the **BEST CHOICE** of Steel Building Panels for the post frame industry; plus the largest selection of Soffit, Fascia, Gutter, Vents, Trim, Trim Coil & Custom Bent Trim.

Note: Color chips show approximate tone. Color of actual product may vary. Final color approval should be made with actual material.





STAFF COMMENTS

Project Name: Ellen Thompson – formerly Doc Thompson Plumbing

Project Address: 1601 Eastgate Parkway

The applicant has submitted a new Certificate of Appropriateness for 1601 Eastgate Parkway, as the previous approval has expired. The parking lot paving and landscaping were not installed during the one year period of validity. There are no changes to the original plan submitted.

Respectfully Submitted By:





STAFF COMMENTS

Project Name:

Ellen Thompson – formerly Doc Thompson Plumbing

Project Address:

1601 Eastgate Parkway

- Stormwater management shall be provided per - Enjoyed drangs shall be submitted for review by the life Engineer. City lods.

Respectfully Submitted By: Policy S. Triest





STAFF COMMENTS

Project Name:

Ellen Thompson – formerly Doc Thompson Plumbing

Project Address:

1601 Eastgate Parkway

No Comment

Respectfully Submitted By:

Tony (611, 2)



STAFF COMMENTS

Project Name:

Ellen Thompson – formerly Doc Thompson Plumbing

Project Address:

1601 Eastgate Parkway

the Building Department has no comments.

Respectfully Submitted By:

Kenneth w. Fultz Chief Building Official



STAFF COMMENTS

Project Name:

Ellen Thompson – formerly Doc Thompson Plumbing

Project Address:

1601 Eastgate Parkway

Planning & Development has no objections to the proposed application. The application was previously approved but not constructed (completed.

Respectfully Submitted By:

DR CADITAL OF



STAFF COMMENTS

Project Name:

Ellen Thompson – formerly Doc Thompson Plumbing

Project Address:

1601 Eastgate Parkway

FIRE CODE HAS NO REQUIREMENTS FOR PRIVATE VEHICLE STORAGE.

Respectfully Submitted By:

TEVE WEZSH MIFAIN FAC



STAFF COMMENTS

Project Name:

Ellen Thompson – formerly Doc Thompson Plumbing

Project Address:

1601 Eastgate Parkway

SANITARY SEWER, WATEN, STORM SEWEL NO COMMENTS. SITE PLAN HAS ENGINEERING APPROVAL

Respectfully Submitted By:

All Fitty 04/01/15