

ZONING DIVISION 200 S. Hamilton Road Gahanna, Ohio 43230 614-342-4025 zoning@gahanna.gov www.gahanna.gov

DESIGN REVIEW/CERTIFICATE OF APPROPRIATENESS

Project/P	roperty Address	or Location:			Project Name/Bu	siness No	ame			
	7 N. HAM				ONTE CHURCH					
Parcel ID		TEPON N	Zoning Design	anation:			al Acreage:			
ll .	25-00-	1918	Zoning Desig	M3	9/11/2020		16			
Please che	eck all that apply:	1770	1120							
	TE PLAN	LANDSCAPI	NG B	UILDING	DESIGN DE	MOLITIO		OTHER		
							to Code Chapter 1150, Olde			
Project De	escription:						Gahanna			
	LOBBY K	ENDICATION	11/							
	20007	1100 V/7 5 71								
APPLICA	NT Name -do not	tura a business no	ame.		Applicant Addr	ess:			A CONTRACTOR OF THE PARTY OF TH	
			anic.							
Do	7 V · O Do.	niNR			128 ACA	Dany	Woods Ik	₹		
Applicant	t E-mail:				Applicant Phone	e No.:	Waas Da -8899			
	DOMINE 6		L. Con		614-	582-	-8899			
BUSINESS	S Name (if applica	ble):								
		Please List Prim	ary Contact fo	r Corres	Contact Informa	ist all app	plicable contacts)			
Name(s):					1 ,					
NE	ED RUYKA	VAVER			(205) 8	34 -	2002			
1	CHITECT				NEO	(205) 934 - 200 Z NEO D CHURCHOFTHER HIGHLANDS. CON				
170					141000	JADICCIA	01. 12 (14/01)	igus.	.004	
PROPER	TY OWNER Name	e: (if different from	Applicant)		Property Owne	r Contac	t Information (pho	ne no./email):		
							VE DEEN COMP	LETED /	0.8.21	
							VE BEEN COMP			
I certify t	that the inform	ation on this a <sub>l</sub>	pplication is	comple	te and accurate	e to the	best of my kno	wledge, ar	nd that	
the proje	ect as describe	d, if approved	l, will be com	pleted	in accordance	with the	e conditions and	d terms of th	nat	
approva				>				0	1-1	
Applican	nt/Primary Con	tact Signature	:			>		_ Date: 🏄	11/2020	
	seto El								*	
					101	, ]		$\Lambda$		
USE				RECE	IVED: LAM	/	PAID: _50	.00		
NAL		DAMA	3-2020		8-19-20	120	DATE: 8-19	2 7070		
NTERNAL USE	Zoning File No	NK UZU	) ded	DATE	0//00	00	DATE: 077	2000		



# **MATERIAL LIST**

ltem	Manufacturer Name	Color Name	Color Number
Awnings	ALUCABONO, DMI OR EQUAL	CHARCOAL GREY	CHARCOA L GRFY
Brick	ExISTING		
Gutters and Downspouts	DMI - DIMENSIONAL MATALS INC	WHITE	WHITE
Lighting	LITHONIA # RSAO OMERO	CLEAR ANNODISED	
Roofing	FIRESTONE TRO OR EQUAL	WHITE	WHITE
Siding	DMI - 12" FLUSH PARL	WH177	WHITE
Stucco	STO POWER WALL	WHITE	34437
Trim	DMI	WHITK	WH 1752
Windows	KAWNFER OR EQUAL	CLEAR ANNODIZED	
Other (please specify)			
Other (please specify)			

#### Please Note:

The Public Hearing will not occur until the City Of Gahanna Staff reviews the Application for Code Consistency. Applications that are not consistent with the code will not be scheduled for hearing.

# ONE CHURCH Addition and Renovations

817 N. Hamilton Rd. Gahanna OH 43230 Construction Documents August 14, 2020

# **CHURCH**

**ONE CHURCH Gahanna Campus** 

817 N. Hamilton Rd. Gahanna Oh 43230

Phone: (614) 407-4115

# CONTRACTOR

**Elevated Integrity Construction** Services, LLC

1055 W. Market Street, Suite F Baltimore, Ohio 43105

Phone: (740) 400-5038

# **ARCHITECT**

**Project 29 Eleven, LLC Architect Ned Ruykhaver** 

PO Box 308 Moravian Falls, NC 28654

Phone: (205) 834-2002

	Sheet List Architectural
Sheet Number	Sheet Name

A0.1	Title Sheet and Drawing Index
A0.2	General Information/Demolition Plan
A1.1	Floor Plan
A1.2	Enlarged Plans and Details
A1.3	Existing Mezzanine/Common Elevation
A1.4	RCP/Roof Plan and Details
A2.1	Schedules and Details
A3.1	Elevation/3D Views
A4.1	Building Sections/Wall Sections
A4.2	Building Sections
A5.1	Millwork Detail
AS.1	Site Plan

Grand total: 12

	Sheet List Structural
Sheet Number	Sheet Name

S0.1	Structural Notes
S-1	Structural Demolition, Foundation Plan, Sections & Details
S-2	Roof Framing Plan
S-2.1	Masonry Wall Section and Details
S-2.2	Masonry Wall Section and Details
S-2.3	Masonry Wall Section and Details
S-3	Framing Elevations
S-4	Structural Steel Framing Details
S-4.1	Typical Walls Section
S-4.2	Typical Wall Section


Sheet List Mechanical							
Sheet Number Sheet Name							
M101 Mechanical Demolition Plan							
M102 New HVAC Plan and Isometric							
M103 Reflected Ceiling Plan & Schedule							
M104 Sections, Schedules & Notes							

	Sheet List Plumbing					
Sheet Number	Sheet Name					
P1.1	Plumbing Floor Plans, Sanitary Stack Diagram, Roof Plan					
DQ1	Plumbing Specifications					

Plumbing Specifications Grand total: 3

	Sheet List Electrical
Sheet	
Number	Sheet Name

Electrical Lighting Plan Partial Electrical Upper Mezzanine Plan Electrical Power Plan Existing Electrical Riser Diagram - To Remain Revisions

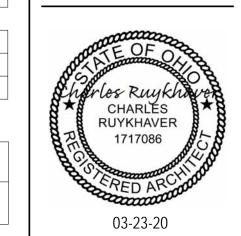



One Church Addition & Renovations

> Client Name One Church

Project Address 817 N. Hamilton Rd. Gahanna OH 43230

03-19

Project Number

0814-20

Title Sheet and Drawing Index

A0.<sup>2</sup>

#### **ABBREVIATION** ABOVE FINISHED FLOOR LAM. LAMINATE (D) ADD. ADDENDUM LAV. LAVATORY ADJ. ADJUSTABLE (MENT) L.H. LEFT HAND A/C ALT. AIR CONDITIONING LENGTH (LONG) **ALTERNATE** ALUM. ALUMINUM LT.WT LIGHTWEIGHT A.B. ANCHOR BOLT LINEAR FOOT ANOD. ANODIZED L.L. LIVE LOAD APPROX LVR. APPROXIMATE (LY LOUVER BSMT. MFR. MANUFACTURE (ER) **BASEMENT** B.M. MDF. MEDIUM DENSITY FIBERBOARD **BENCH MARK** MAS. M.O. MATL BM. MASONRY BEAM BRG. **BEARING** MASONRY OPENING BLK. BLOCK MATERIAL (S) BD. BOARD MAX. MAXIMUM BLDG BUILDING MECH. MECHANIC (AL) CAB. CPT. **CABINET** METER (S) **CARPET** MM. MILLIMETER (S) CSMT MWK. CASEMENT MILLWORK CLG. C.T. MIN. MISC. MINIMUM (S) CEILING **CERAMIC TILE MISCELLANEOUS** C.M.T MOD. CERAMIC MOSAIC TILE MODULAR CLR. C.O. MT. CLEAR MOUNT (ED), (ING) MULL CLEAN OUT MULLION CL. COL. CONC. CLOSET N.R. **NOISE REDUCTION** COLUMN N.R.C. NOISE REDUCTION COOEFFICIENT NOM. CONCRETE NOMINAL C.M.U. CONCRETE MASONRY UNIT NORTH CONST N.I.C. NOT IN CONTRACT CONT. C.J CF. N.T.S. NOT TO SCALE CONTINUOUS O.C. OPNG. **CONTROL JOINT** ON CENTER CUBIC FOOT OPENING CY. OPP. O.D. CUBIC YARD **OPPOSITE** D.E.F.S DIRECT APPLIED EXTERIOR **OUTSIDE DIAMETER** FINISHING SYSTEM D.L. DTL. DIAM. DIM. DEAD LOAD PANEL PAR. DETAIL PARALLEL PK. **PARKING** DIAMETER DIMENSION PAV. **PAVING** DR. PVMT. **PAVEMENT** DOOR DN. DS. DWG. PERF. PERFORATE (D) DOWN **DOWNSPOUT** PERIM. PERIMETER P.LAM. PLASTIC LAMINATI DRAWING D.F. **DRINKING FOUNTAIN** PLAM. PLASTIC LAMINATE P.C.F. EAST POUNDS PER CUBIC FOOT E.I.F.S. EXTERIOR INSULATED P.L.F. POUNDS PER LINEAR FOOT P.S.F. POUNDS PER SQUARE FOOT FINISHING SYSTEM ELEC. ELECTRIC P.S.I. POUNDS PER SQUARE INCH PREFAB. **ELEVATION** PREFABRICATE (D) ELEV. ELEVATION PREFIN. PREFINISHED EMER. P.L. **EMERGENCY** PROPERTY LINE EQ. QTY. **EQUAL** QUANTITY QTR. EXH. **EXHAUST** QUARTER (ED) EXIST. EXISTING RAD. RADIUS E.J. EWC. **EXPANSION JOINT** RECEP. **RECEPTACLE ELECTRIC WATER COOLER** REFRIG. REFRIGERATOR EXP. REINF. REINFORCE (D), (ING) **EXPOSED** EXT. **EXTERIOR** R.C.P. REFLECTED CEILING PLAN F.W.C. REQD. FABRIC WALL COVERING REQUIRED F.O.S. FEC. FHC. R.A. FACE OF STUDS **RETURN AIR** FIRE EXTINGUISHER CABINET REV. REVISION (S), (ED) R.H. FIRE HOSE CABINET RIGHT HAND FGL. FIN. R.H.R. RIGHT HAND REVERSE **FIBERGLASS** R.D. FINISH (ED) **ROOF DRAIN** RM. FLOOR (ING) ROOM F.D. R.O. FLOOR DRAIN **ROUGH OPENING FLUOR** SCHED. FLUORESCENT SCHEDULE FT. FTG. SECT. SECTION FOOT (FEET) FOOTING STORE FRONT FND. SHTH. **FOUNDATION** SHEATHING F.R. GA. FIRE RATED SIMILAR S.C. SOLID CORE GAGE, GAUGE GALV GALVANIZED SOUTH **GENERAL CONTRACTOR** S.L.L SOUND AND LIGHT LOCK GLASS, GLAZING SPECIFICATION (S) GYPSUM WALLBOARD SQ. SQUARE SR STAGE RIGHT GWB GYPSUM WALLBOARD HDCP S.S. STAINLESS STEEL HANDICAP HDW. **HARDWARE** STD. STANDARD HWD. HARDWOOD STL. STEEL HDR. STOR. **STORAGE** HEADER HTG. HEATING S.D. STORM DRAIN HVAC HEATING/VENTILATION/AIR CONDITION STRUCT STRUCTURAL H.O. HT. HOLD OPEN SURFACE SUSP. HEIGHT SUSPENDED H.C. SYM. SYMMETRY (OR SYMBOL) **HOLLOW CORE** H.M. HOR. **HOLLOW METAL** TEL. TELEPHONE **TELEVISION** HORIZONTAL T&G T.O.C. H.B. HOSE BIB **TONGUE AND GROOVE** HOT WATER HEATER H.W.H. TOP OF CURB T.O.S. TOP OF SLAB INCL. INCLUDE (D), (ING) T.O.S. T.O.W. TOP OF STEEL

**INSIDE DIAMETER** 

INTERIOR

INVERT

JOINT

JOIST

LABEL

LADDER

KITCHEN

LABORATORY

INSULATE (D), (ION)

JANITOR'S CLOSET

INSUL

INV.

J.C.

JST.

KIT.

LAB.

# **GENERAL INFORMATION**

1. CONDITIONS AND DIMENSIONS - DO NOT SCALE DRAWINGS. FIELD VERIFY ALL DIMENSIONS. CHECK ALL DIMENSIONS AND OTHER IRREGULARITIES PRIOR TO BEGINNING CONSTRUCTION, FABRICATING OR ORDERING ANY MATERIALS. REPORT ANY IRREGULARITIES OR DISCREPANCIES TO ARCHITECT IMMEDIATELY AND ADJUST WORK AS DIRECTED BY ARCHITECT. ANY CHANGES TO THE SCOPE OF THE WORK OR PROJECT SCHEDULE RESULTING FROM DISCREPANCIES BETWEEN THE DRAWINGS AND EXISTING CONDITIONS MUST BE AGREED TO BY THE OWNER, CONTRACTOR, AND ARCHITECT PRIOR TO PROCEEDING WITH THE WORK.

2. SUBCONTRACTORS ARE REQUIRED TO REVIEW THE ENTIRE SET OF CONTRACT DOCUMENTS TO NOTE AREAS OF WORK OF THEIR TRADE ON SHEETS TRADITIONALLY KNOWN AS WORK OF OTHER TRADES. THE ARCHITECT IS TO BE NOTIFIED IN WRITING OF ANY DISCREPANCY AND WILL COORDINATE DESIGN WORK OF THESE ITEMS. THE GENERAL CONTRACTOR IS ULTIMATELY RESPONSIBLE FOR IDENTIFYING AND INCLUDING ALL ITEMS OF WORK INCLUDED IN THE CONTRACT DOCUMENTS.

### 3. CEILING UTILITY COORDINATION

TS 4x4

by 0.188

**TS 8x8** 

by 0.250

screws spaced 12" OC max.

\* Bearing the UL Classification Mark

6 1 & 2 Hour Column Enclosures UL# X528

INSTALL ALL ELECTRICAL AND OTHER CONDUIT TIGHT TO STRUCTURE. CONNECT CEILING GRID AND LIGHTING FIXTURE TIE WIRES TO STRUCTURAL ELEMENTS ABOVE. DO NOT ATTACH TO OTHER SYSTEMS SUCH AS CONDUIT, DUCTS, PIPES, ETC. PROVIDE A MINIMUM OF 1'-0" CLEAR ZONE ADJACENT TO ANY FIRE OR SMOKE PARTITION

4. METAL FRAMING FOR ALL SUSPENDED GYP. BD. SOFFITS, CEILINGS, FURRING, AND OVER ALL DOORS SHALL BE SECURED TO THE STRUCTURE ABOVE AS REQUIRED FOR RIGID INSTALLATION.

5. ALL WOOD, PLYWOOD, BLOCKING, AND FRAMING LOCATED IN FIRE RATED BUILDING ELEMENTS SHALL BE FIRE RETARDANT TREATED.

6. FIREPROOFING OF PENETRATIONS IN PARTITIONS AND FLOORS SHALL BE PER A U.L. DESIGN APPROPRIATE TO THE APPLICATION.

1" 1-3/4" 2-5/8" B C

3. Steel Studs - 1-5/8" wide with 1-5/16" and 1-7/16" legs having 1/4" folded flange, fabricated

**5. Tie Wire-** No. 18 swg steel wore spaced 24 in. OC used with second layer of wallboard.

**4. Corner Beads** - No. 28 MSG galv steel, 1-1/4" legs to be attached to wallboard with No. 6 by 1"

6. Screws- For Attaching first layer of wallboard to steel studs, and third layer of wallboard to 2" by 2"

self tapping double lead screws spaced 24" OC. For attaching second layer of wallboard to steel studs and

thick wallboard) steel screws of the same type spaced 12" OC. For attaching third layer of wallboard to

7. Finishing System - (Not Shown) - Joint compound aaplied over corner beads to a thickness of 1/16"

**ONE AND TWO HOUR COLUMN DETAIL** 

steel angle (25 Ga) to be No. 6 by 1" (or 1-1/4" for 3/4" thick wallboard) Phillips head self-drilling,

fourth layer of wallboard to 2" by 2" steel angle (25 Ga) to be No. 6 by 1-3/4" (or 2-1/4" for 3/4"


from No. 25 MSG galv steel. Length to be 1/2" less than the assembly height.

steel studs to be No. 8 by 2-1/4" screws of the same type spaced 12" OC.

5/8" | 1-1/2" | 2-1/4" | A | C | D

7. PROVIDE SEALANT AT JUNCTURE OF INTERIOR FACES OF DOOR FRAMES, VIEW WINDOW FRAMES. EXTERIOR WINDOW FRAMES, AND CASEWORK WITH ADJACENT MATERIALS EVEN THOUGH JOINT MAY NOT BE VISIBLE.

8. WHERE WALL SURFACES ARE NOTED "ALIGN," THE FINISHED FACE OF NEW CONSTRUCTIONIS TO ALIGN WITH THE FINISHED FACE OF OTHER NEW CONSTRUCTION.

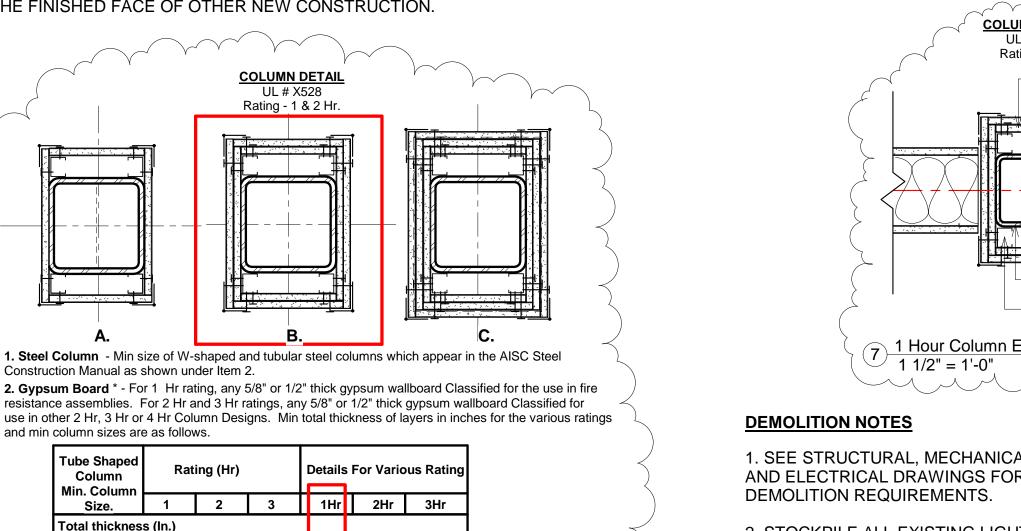

1. SEE STRUCTURAL, MECHANICAL, PLUMBING AND ELECTRICAL DRAWINGS FOR ADDITIONAL

2. STOCKPILE ALL EXISTING LIGHT FIXTURES. VERIFY W/ OWNER PRIOR TO DISPOSAL.

3. STOCKPILE ALL EXISTING DOORS VERIFY W/ OWNER PRIOR TO DISPOSAL.


FIXTURES. VERIFY W/ OWNER PRIOR TO DISPOSAL.


ITEMS NOT SHOWN ON THE DEMO PLAN, VERIFY W/ OWNER AND ARCHITECT PRIOR TO PROCEEDING.

6. RELOCATE SPRINKLER HEADS AS NECCESSARY TO CENTER IN NEW ROOMS AND CEILING GRIDS.

Demolition Plan

1/16" = 1'-0"

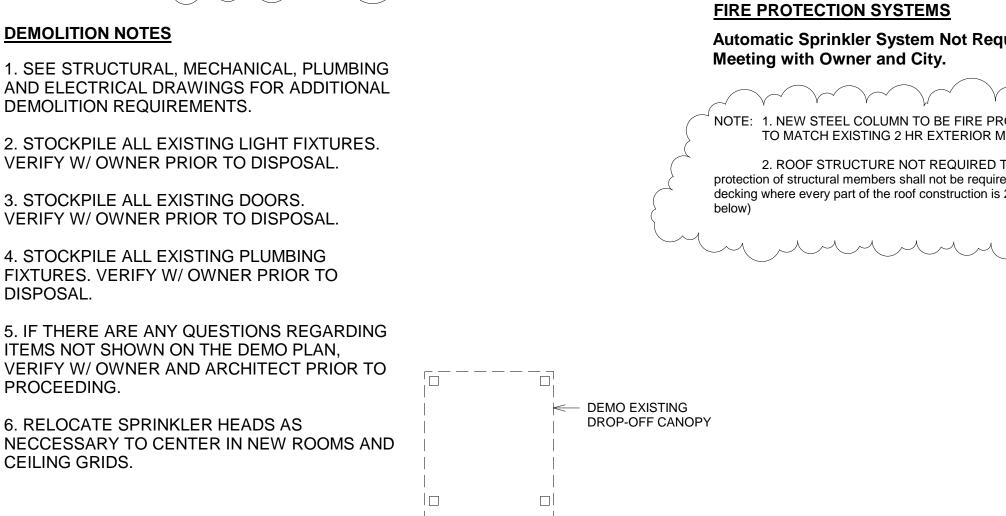

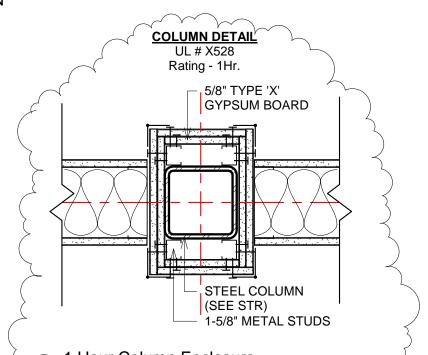

**Automatic Sprinkler System Not Required Per** 

**ONE CHURCH** 

to Existing Building

817 N. Hamilton Rd

Gahanna OH 43230

**Applicable Codes** 

**Project Description:** 

The roof is a shingled roof.

Number of Floors: One

Renovations Phase:

**OBC CODE PROVISIONS** 

TYPES OF CONSTRUCTION

Including columns, girder, trusses

Nonbearing walls and partitions

Nonbearing walls and partitions

Including supporting beams and joists

Structural Frame

Bearing walls

Exterior

Exterior

Interior

Floor construction

Roof construction

Interior

Renovations and Alterations

Ohio Building Code and Admendments

The existing construction type is Type IIIA.

The exterior walls are load bearing CMU

The existing building is a 54,785 sq.ft. Assembly Building.

and the roof structure steel bar joists and wood rafters.

Phase1 renovations consist of adding a new entry lobby.

min pur pur

Existing Building Area Total: **54,785 gross square feet** 

8,500 gross square feet

1 Hour

2 Hour

1 Hour

0 Hours

1 Hour

1 Hour b.

0 Hours per Table 602

Building Height (measured from Floor to highest roof ridge): 30'- 0" +/-

Fire Resistance Ratings for Building Elements of Type IIIA Construction:

The existing building is currently NOT sprinklered.

A new Cafe will be added in the existing space.

**GENERAL BUILDING INFORMATION** 

**USE AND OCCUPANCY CLASSIFICATION** 


The primary occupancy is A-3 Assembly Occupancy.

Occupancy Type: Assembly Group A-3

NOTE: 1. NEW STEEL COLUMN TO BE FIRE PROTECTED 1 HRS WITH GYPSUM BOARD TO MATCH EXISTING 2 HR EXTERIOR MASONRY WALLS.

2. ROOF STRUCTURE NOT REQUIRED TO BE RATED PER OBC CHAPTER 6 (fire protection of structural members shall not be required, including protection of roof framing and decking where every part of the roof construction is 20 feet or more above any floor immediately

b. Except in Group F-1, H, M and S-1 occupancies, fire protection of structural members shall not be required, including protection of roof framing and decking where every part of the roof construction is 20 feet or more 7 1 Hour Column Enclosure above any floor immediately below. My My Mary

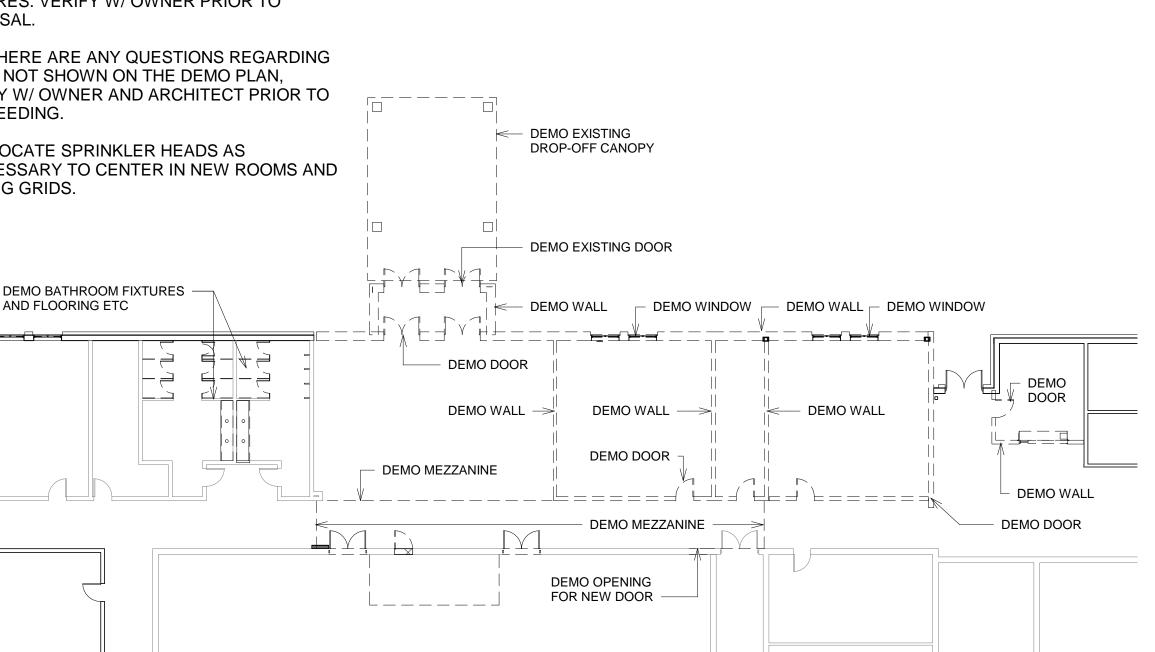

Revisions

Revision Date No. Description 5-27-20 1

CHARLES RUYKHAVER 1717086

03-23-20

One Church Addition & Renovations


> Client Name One Church

Project Address 817 N. Hamilton Rd. Gahanna OH 43230

Project Number 03-19

0814-20

General Information/Demolition Plan

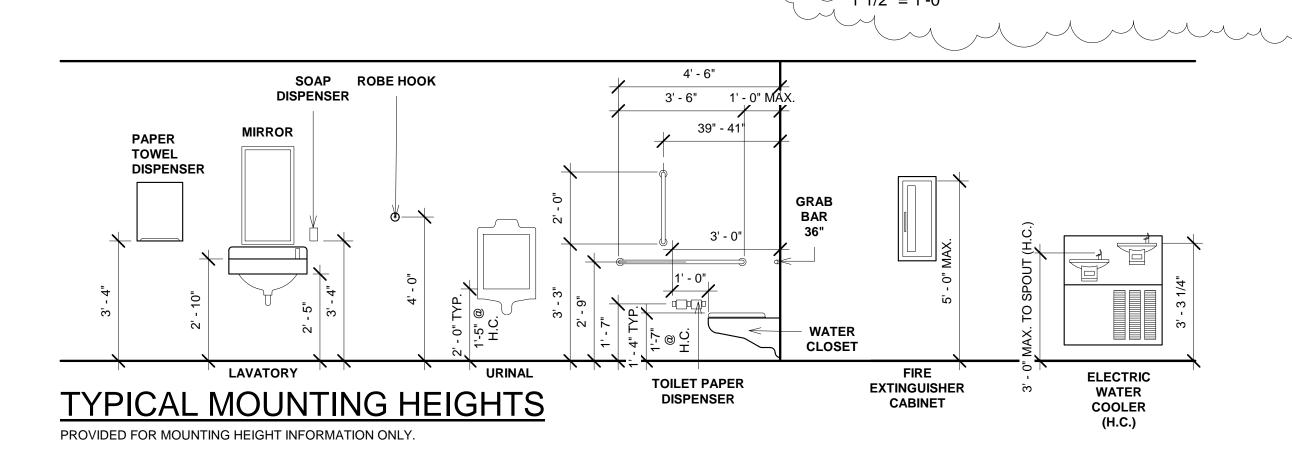

TOP WALL

VERTICLE

VESTIBULE

WALL HUNG

WIDTH. WIDE

WEIGHT

WINDOW

WOOD

WATER CLOSET

UNDERWRITER'S LAB. INC.

VINYL COMPOSITION TILE

WELDED WIRE FABRIC

UNLESS NOTED OTHERWISE

WIDE FLANGE STEEL SHAPE

**TYPICAL** 

TYP.

U.L.

U.N.O.

VERT.


VEST.


V.C.T.


W.C.

WT.


W.W.F

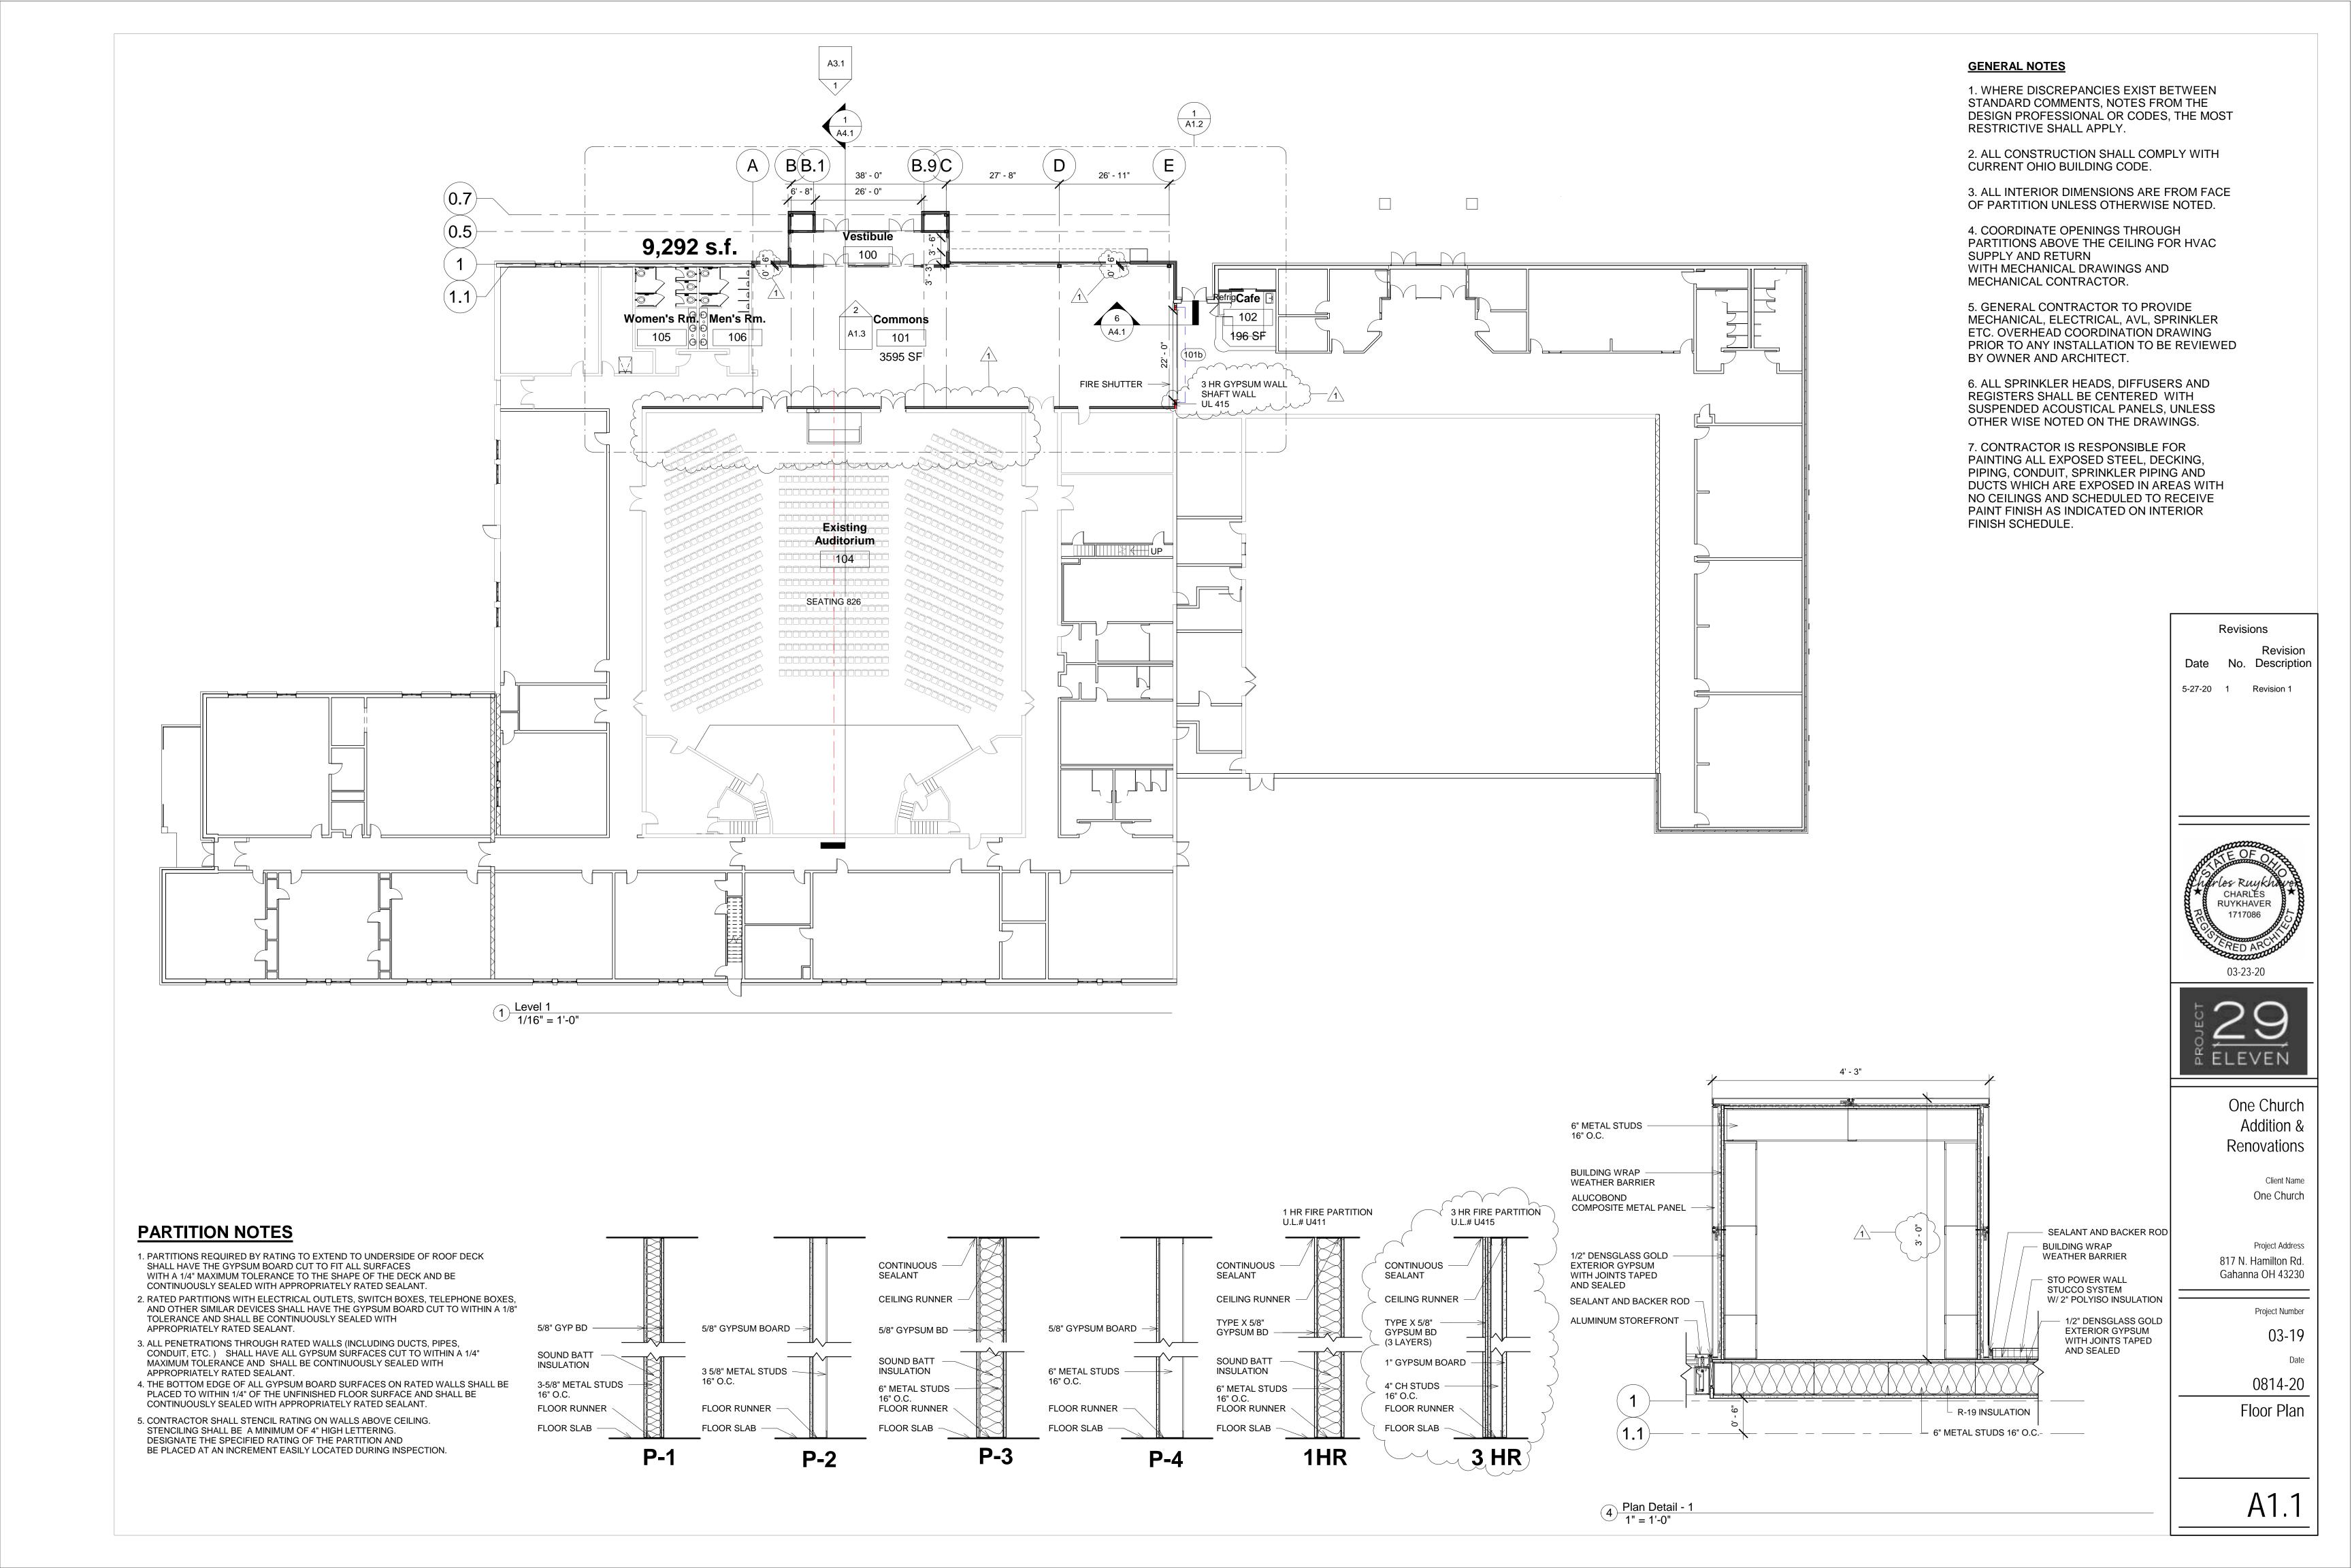

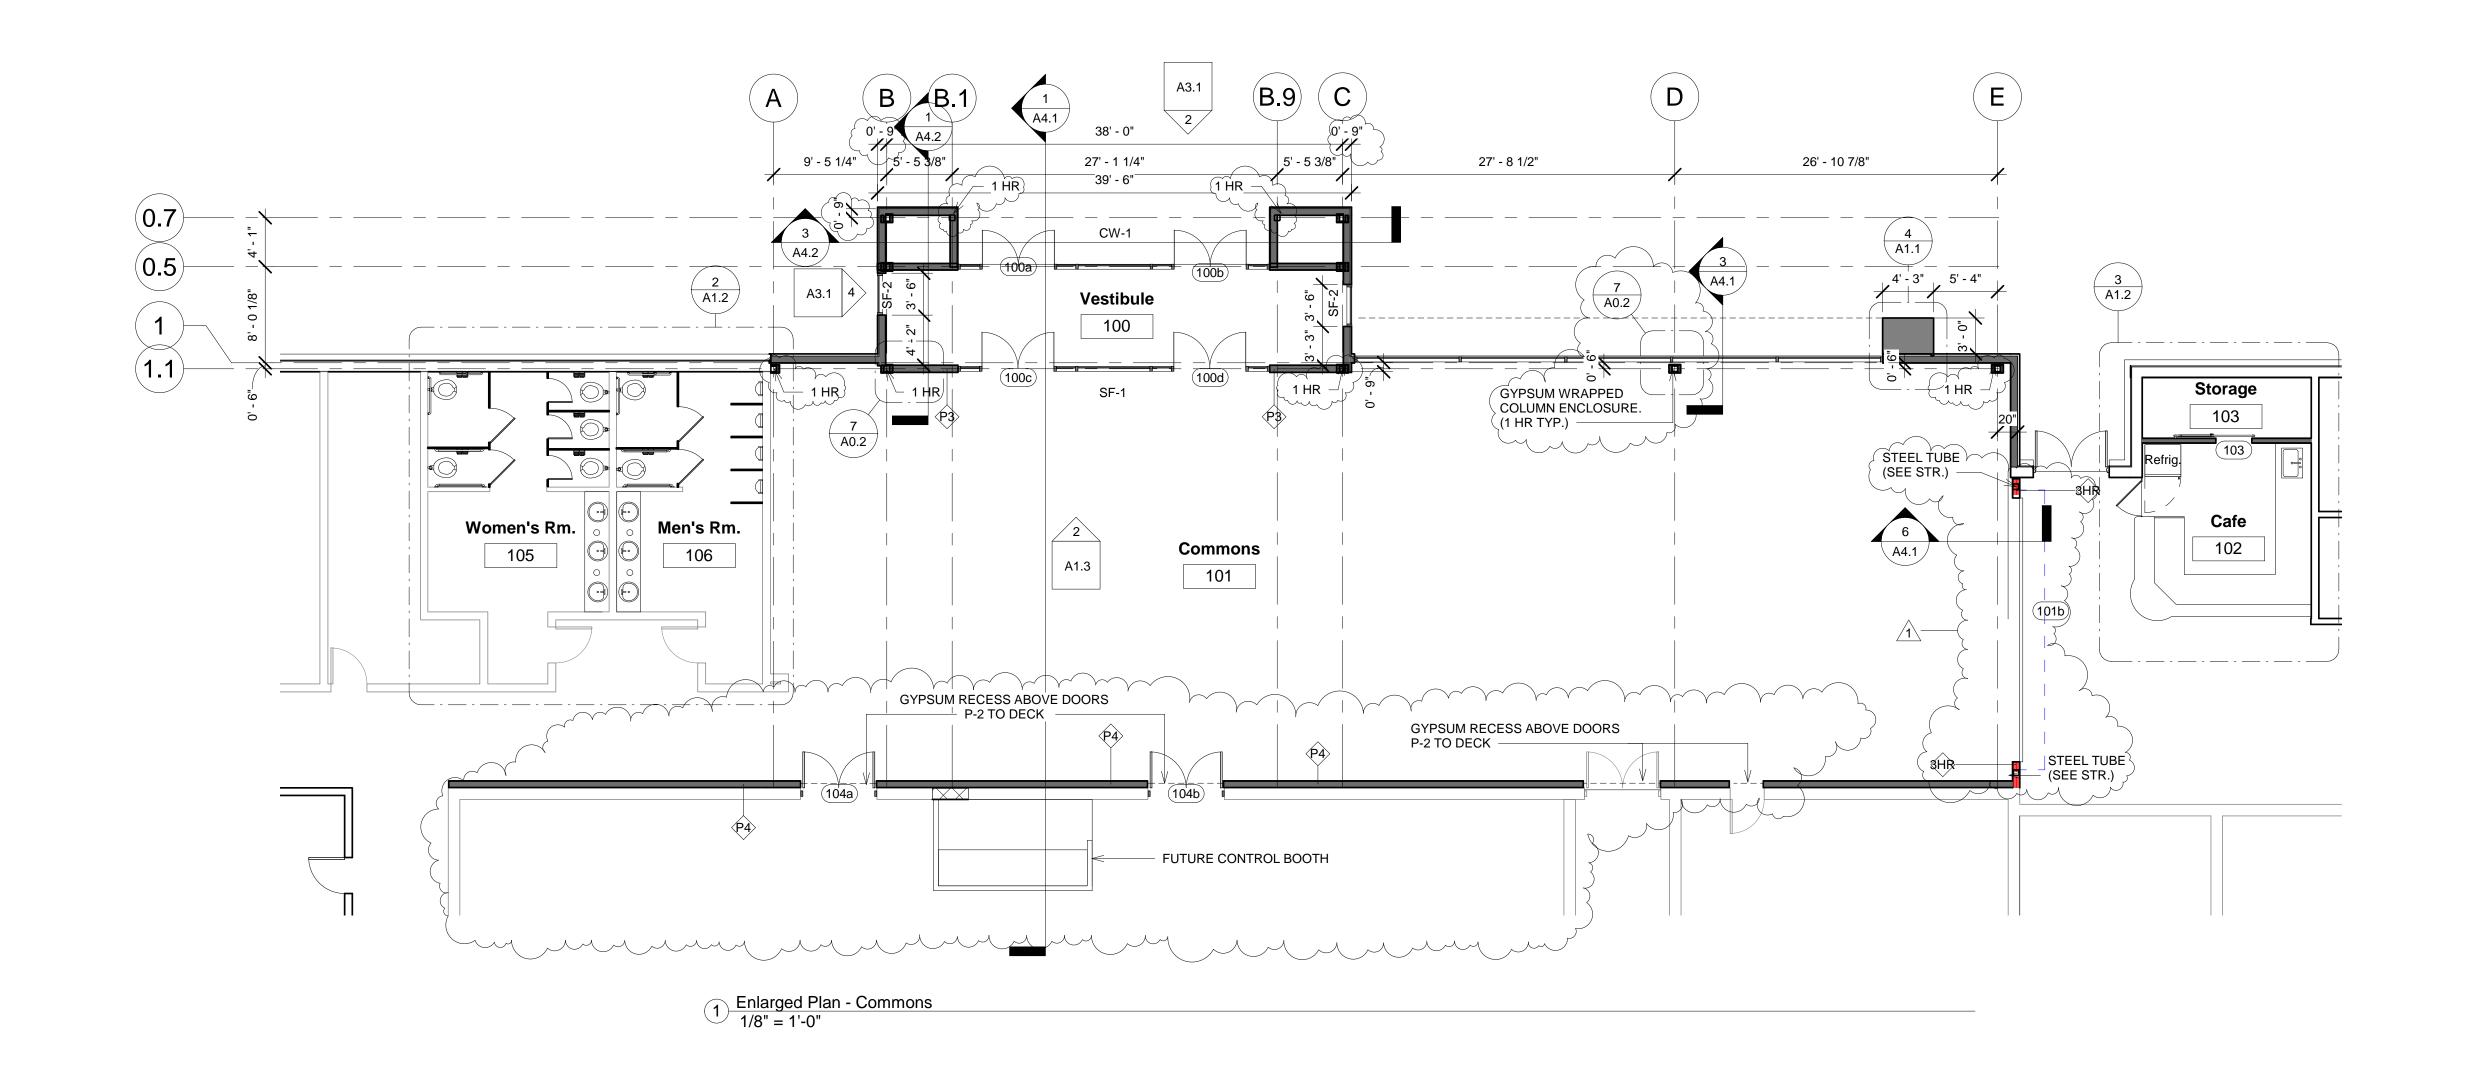

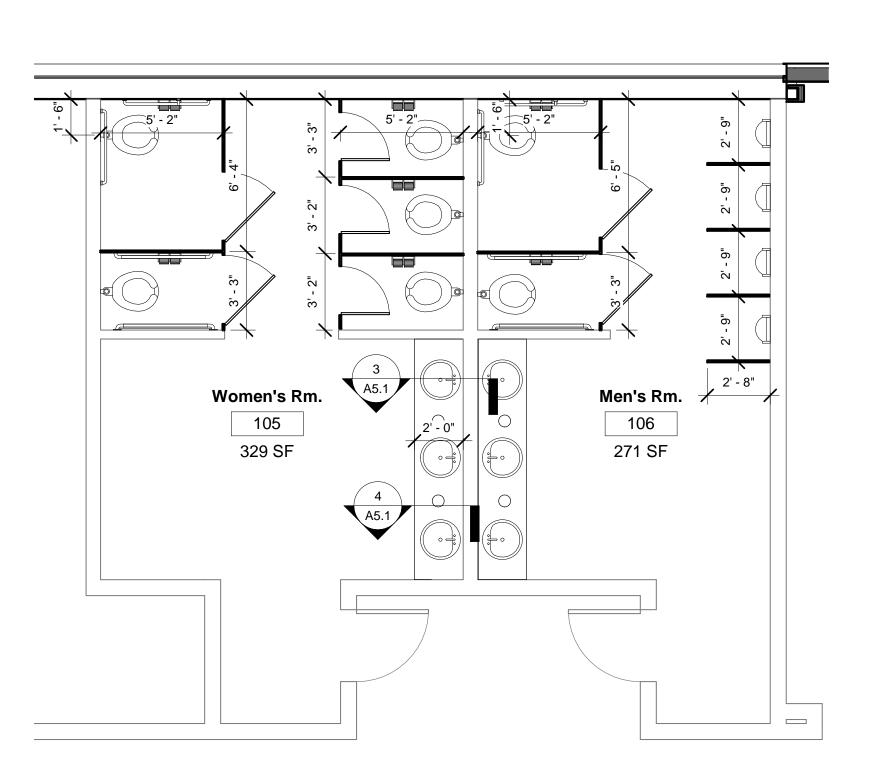


2 Enlarged Plan - Renovated Restrooms
1/4" = 1'-0"

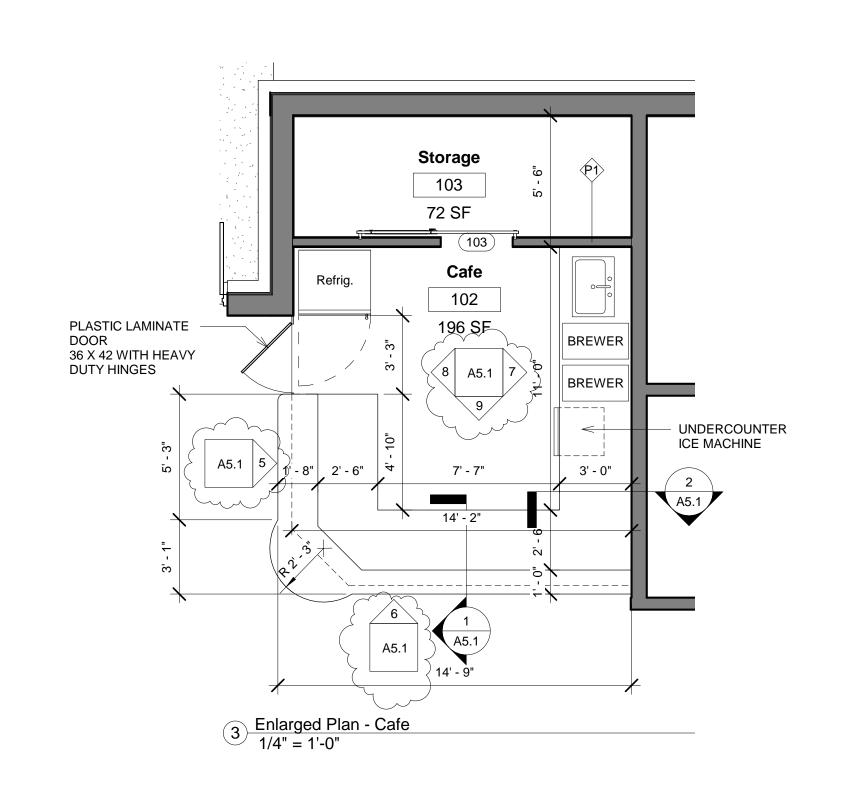

Revisions

Date No. Description

5-27-20 1 Revision 1

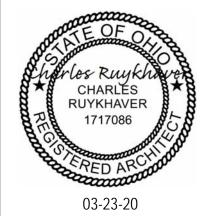

Navara Navara Navara Navara Navara

> One Church Addition & Renovations

> > Client Name
> > One Church


Project Address 817 N. Hamilton Rd. Gahanna OH 43230


Project Number 03-19

Date 0814-20

Enlarged Plans and Details


A1.2

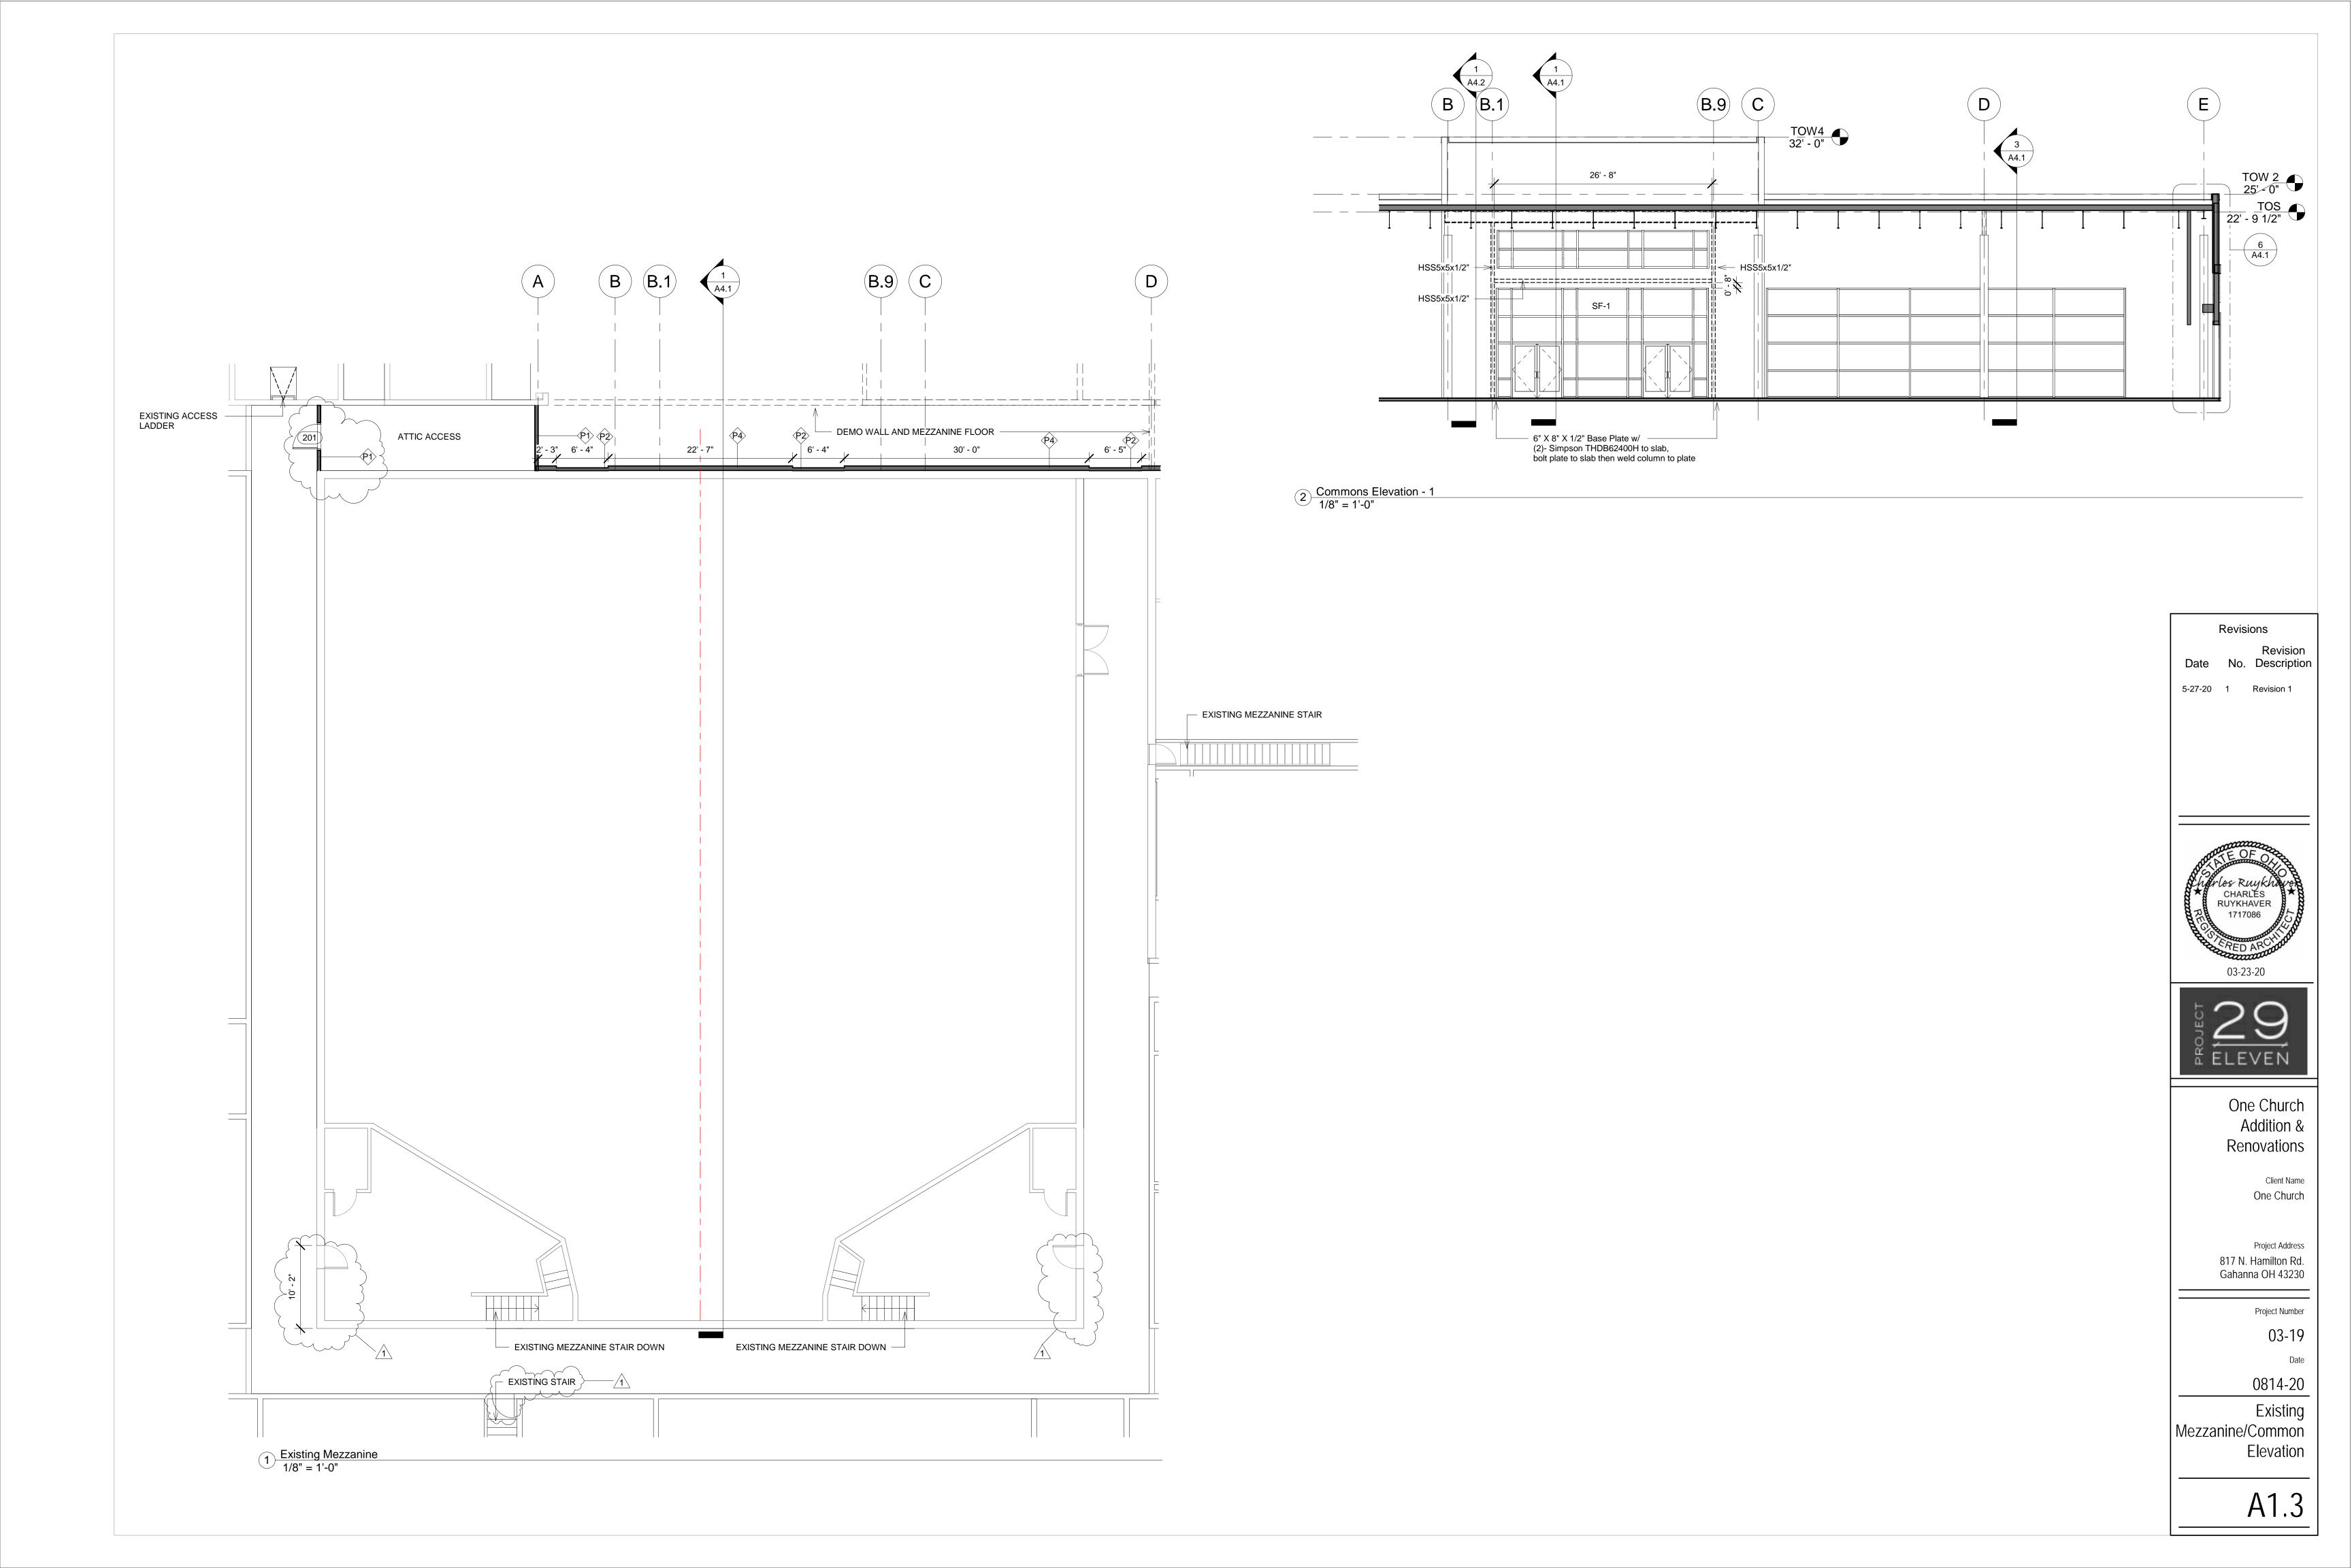


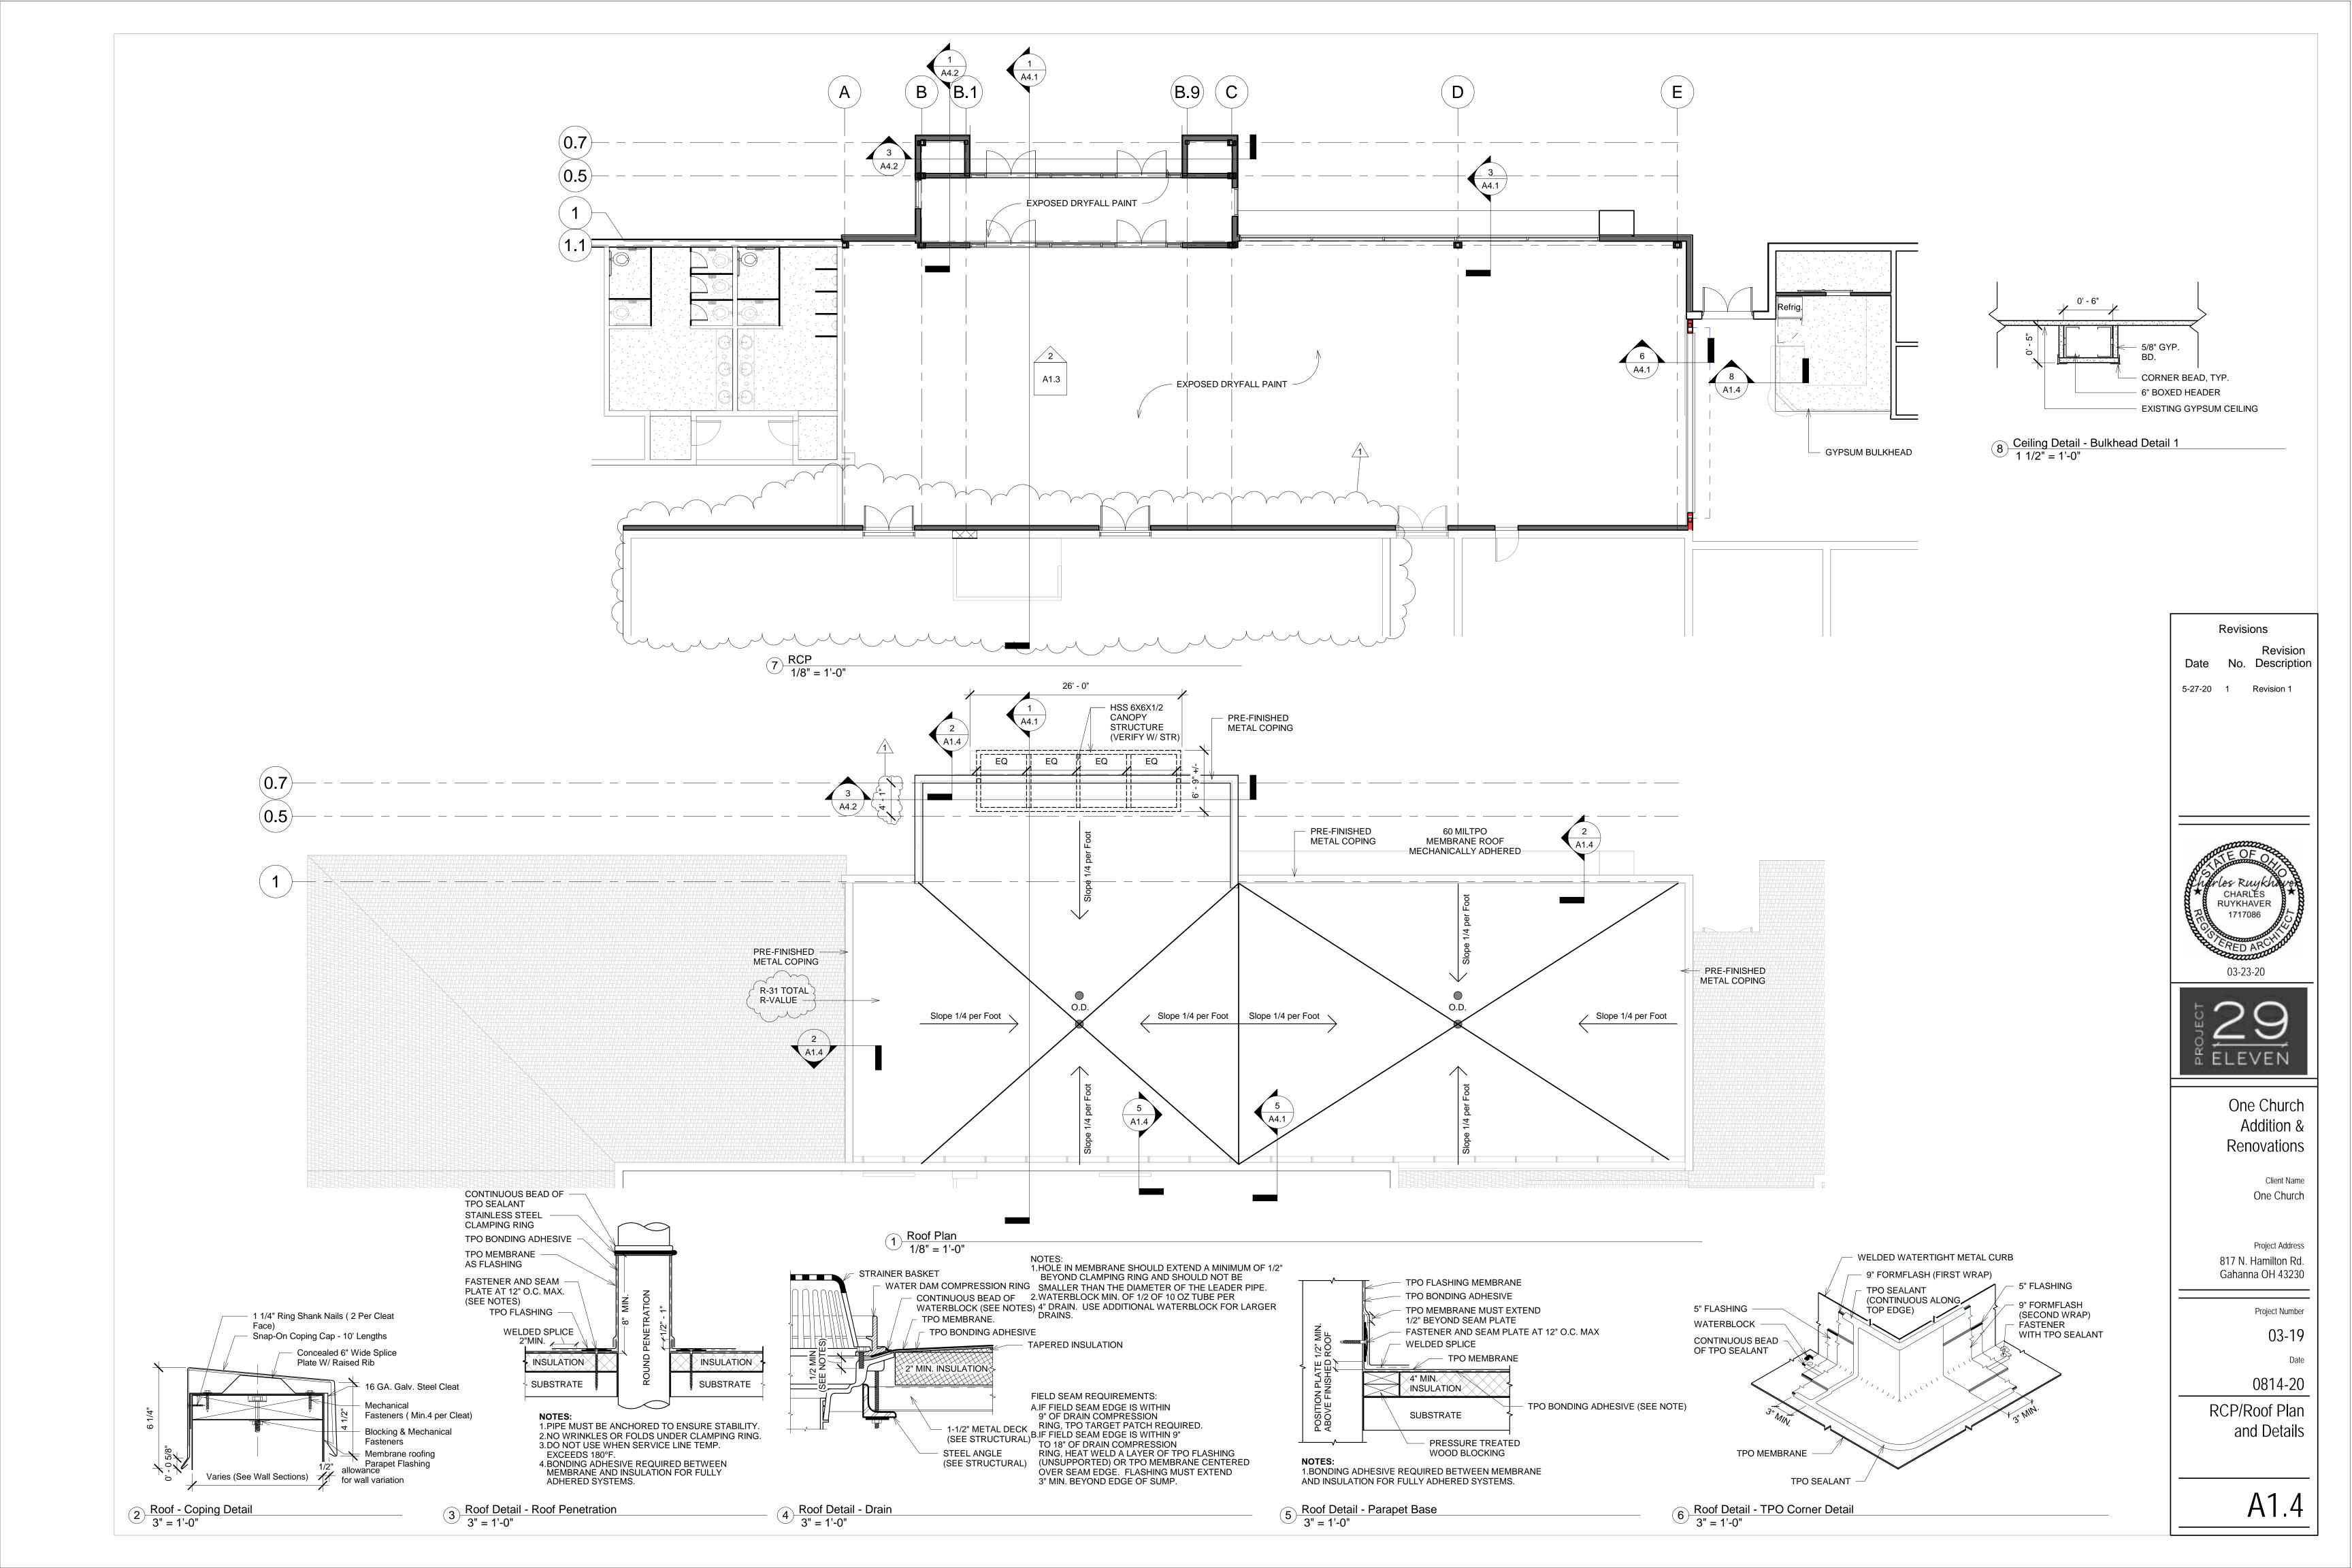

			Room S	schedule	
Roo m Num ber	Room Name	Floor Finish	Base Finish	Wall Finish	Ceiling Finish
100	Vestibule	Walk Off Matt	Rubber	Painted Gypsum Bd.	Exposed Dryfall
101	Commons	ĹVT	Rubber	Painted Gypsum Bd.	Exposed Dryfall
102	Cafe	Polished Concrete	Rubber	Painted Gypsum Bd.	Patch and Paint Existing Gypsum
103	Storage	Sealed Concrete	Rubber	Painted Gypsum Bd.	Patch and Paint Existing Gypsum
104	Existing Auditorium	Existing	Existing	Painted CMU	Existing Exposed
105	Women's Rm.	Tile	Tile	Painted Gypsum Bd./Tile @ 48" Wet Wall	Patch and Paint Existing Gypsum
106	Men's Rm.	Tile	Tile	Painted Gypsum Bd./Tile @ 48" Wet Wall	Patch and Paint Existing Gypsum

							Door Schedule						
Door Numb				Door				Frame			Panic Hardw		
er	Туре	Hardware	Width	Height	Thickness	Material	Finish	Material	Frame Finish	Closers	are	Fire Rating	Comments
100a	SF1		6' - 0"	7' - 0"	0' - 1 3/4"	Aluminum Storefront	Clear Anondized	Aluminum	Clear Anodized	Vas	Yes		
100b	SF1		6' - 0"	7' - 0"	0' - 1 3/4"	Aluminum Storefront	Clear Anondized		Clear Anodized		Yes		
100c	SF1		6' - 0"	6' - 8"	0' - 1 3/4"	Aluminum Storefront	Clear Anondized	Aluminum	Clear Anodized	Yes	Yes		
100d	SF1		6' - 0"	6' - 8"	0' - 1 3/4"	Aluminum Storefront	Clear Anondized	Aluminum	Clear Anodized	Yes	Yes		
101b	OVH		22' - 0"	9' - 0"	0' - 3"	Metal	Pre-Finished			-	-	1 Hour	1HR Fire Shutter
103	D3		3' - 0"	7' - 0"		Wood	Stained	-	-	-	-		Barn Door Hardware
104a	D4		6' - 0"	7' - 0"	0' - 1 3/4"	Solid Core Wood	Stained	Hollow Metal	Painted	Yes	Yes	1 Hour	
104b	D4		6' - 0"	7' - 0"	0' - 1 3/4"	Solid Core Wood	Stained	Hollow Metal	Painted	Yes	Yes	1 Hour	
104c	D2		6' - 0"	7' - 0"	0' - 1 3/4"								
201	D1		3' - 0"	7' - 0"	0' - 1 3/4"	Wood	Stained	Hollow Metal	Painted	Yes	Yes		Mezzanine Attic Access

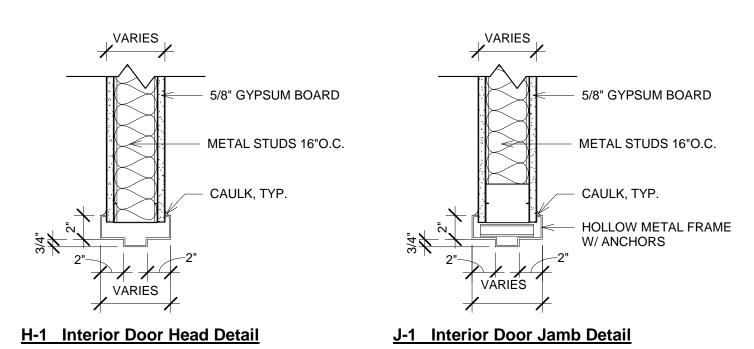

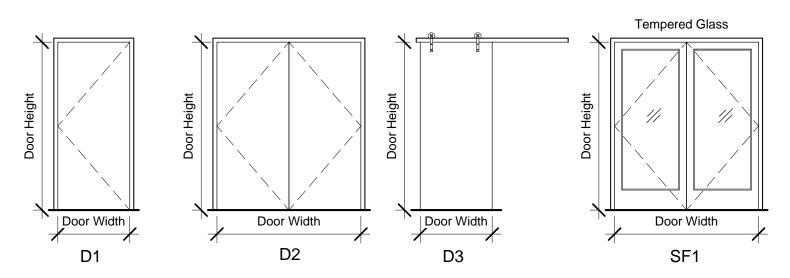

Revisions

Revision
Date No. Description

5-27-20 1 Revision 1



03-23-20



One Church Addition & Renovations

Client Name
One Church

Project Address 817 N. Hamilton Rd. Gahanna OH 43230


Gahanna OH 43230


Project Number 03-19


0814-20


Schedules and Details

Δ21

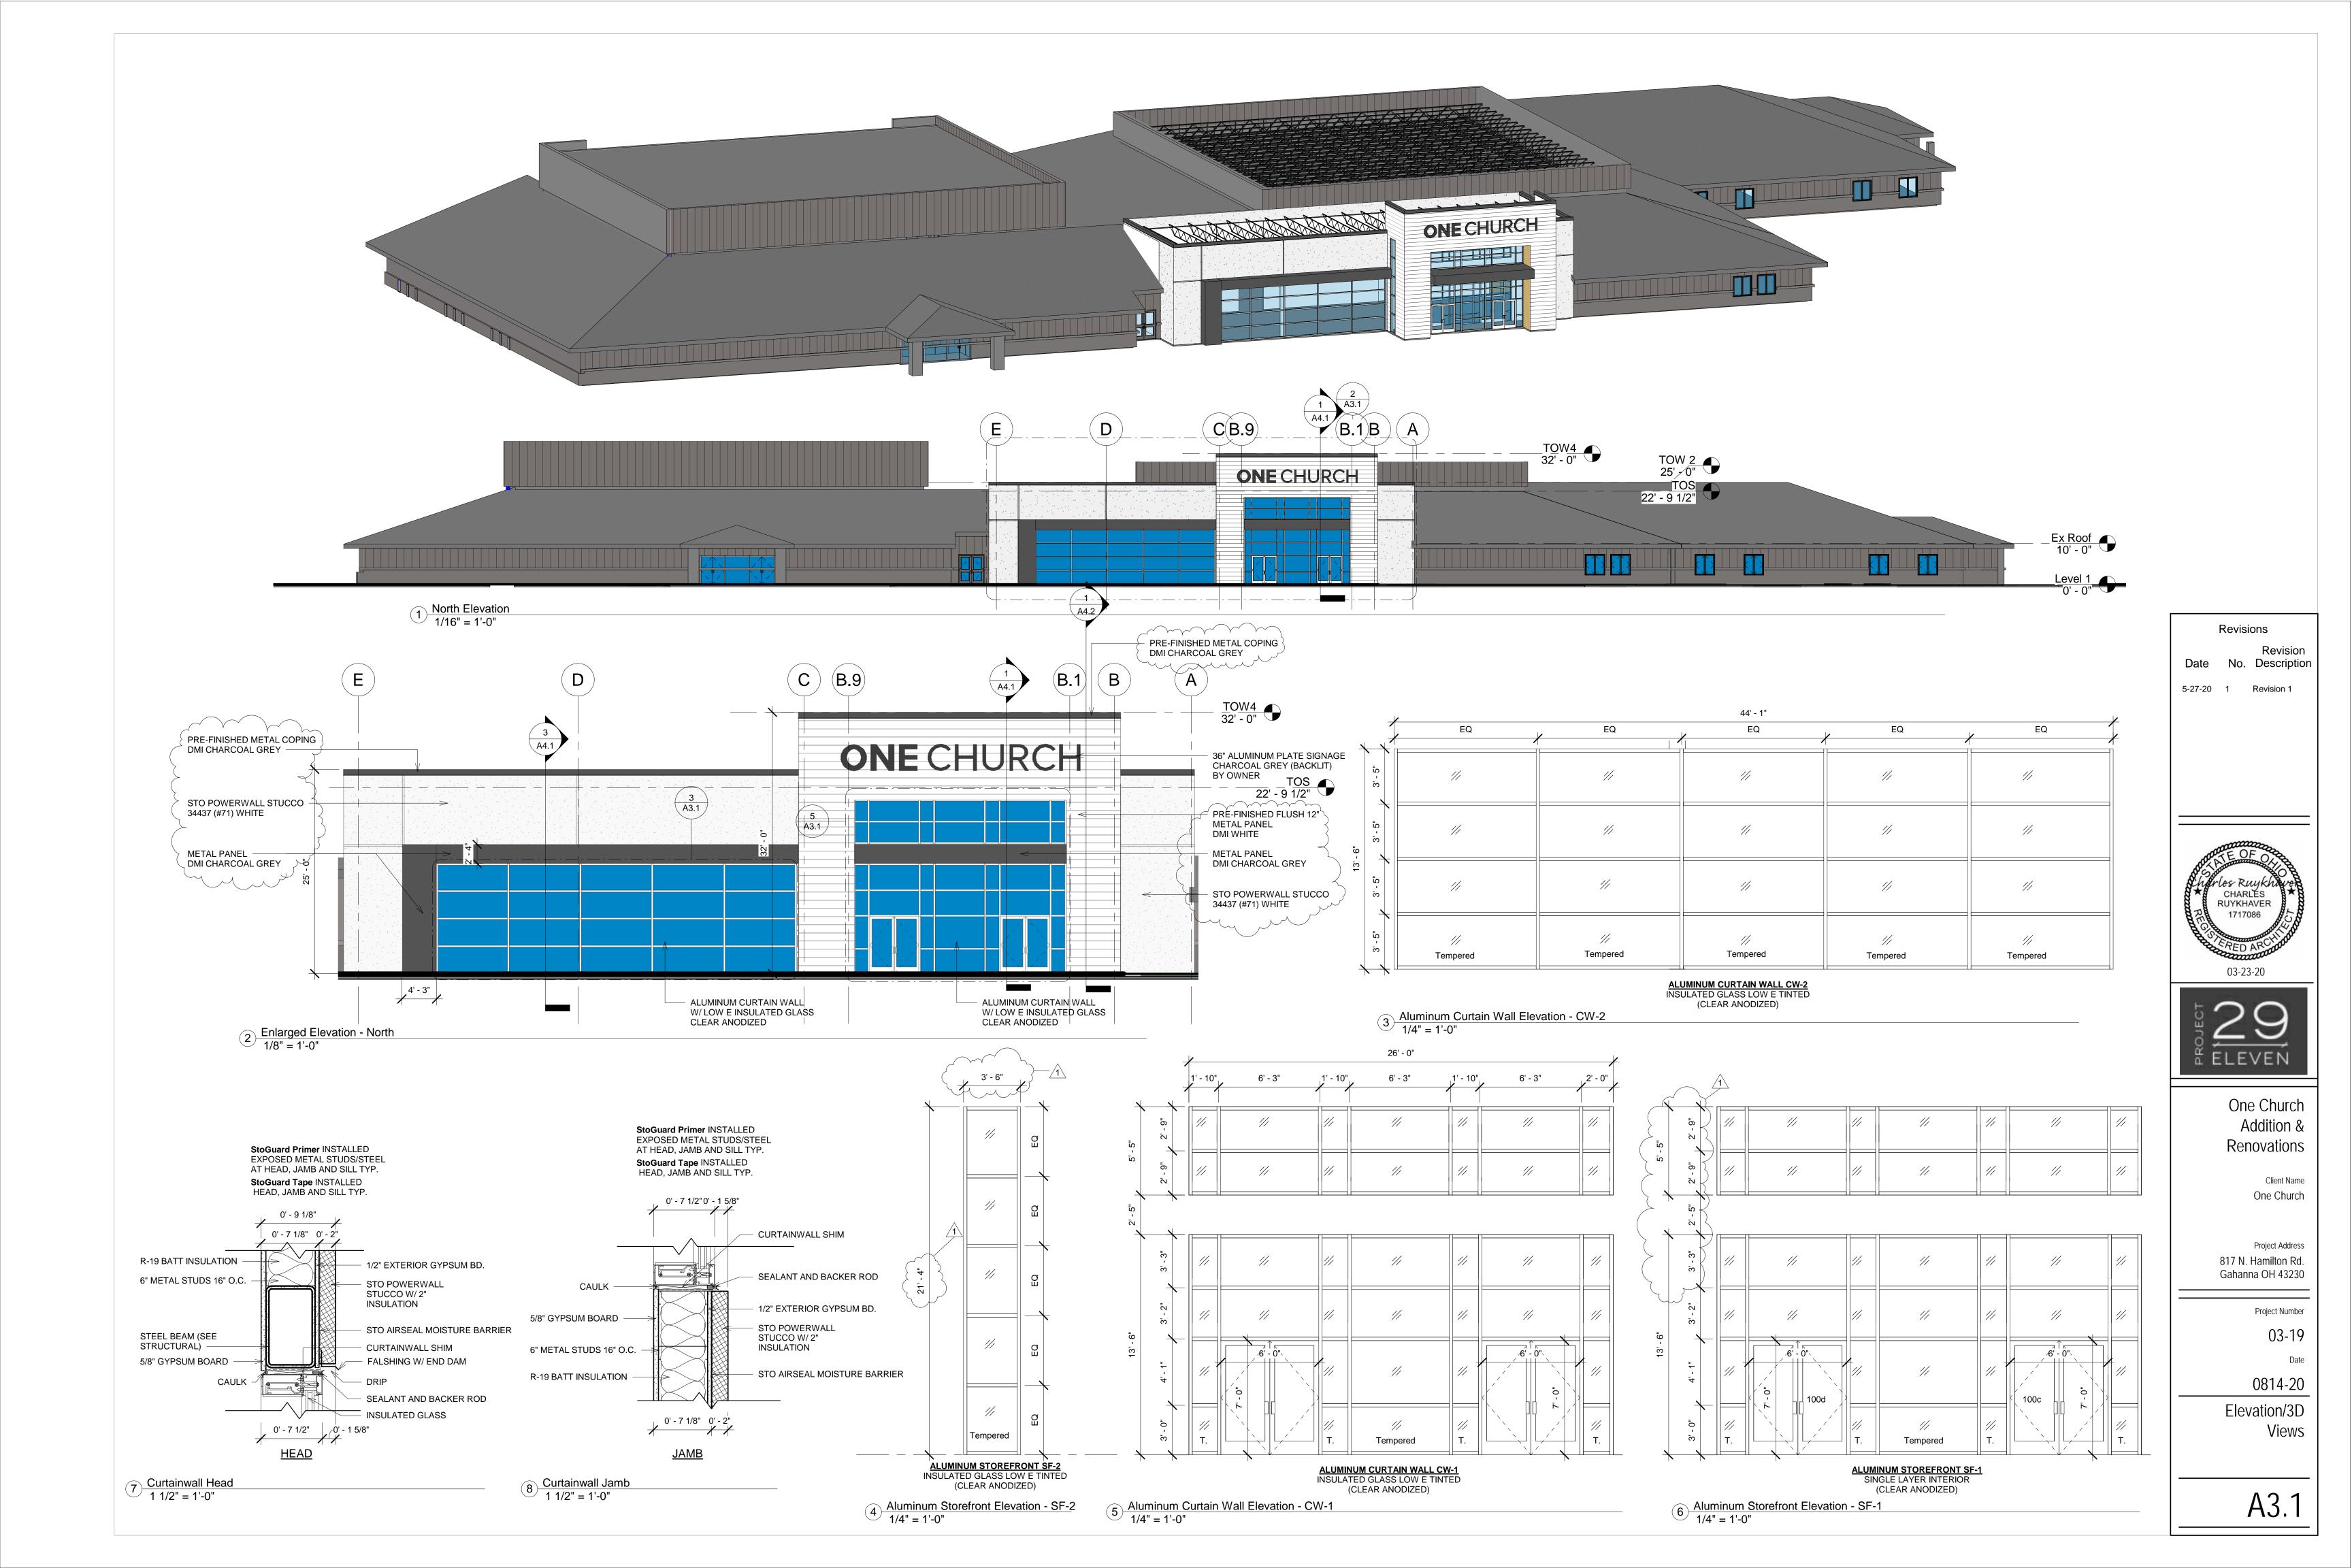

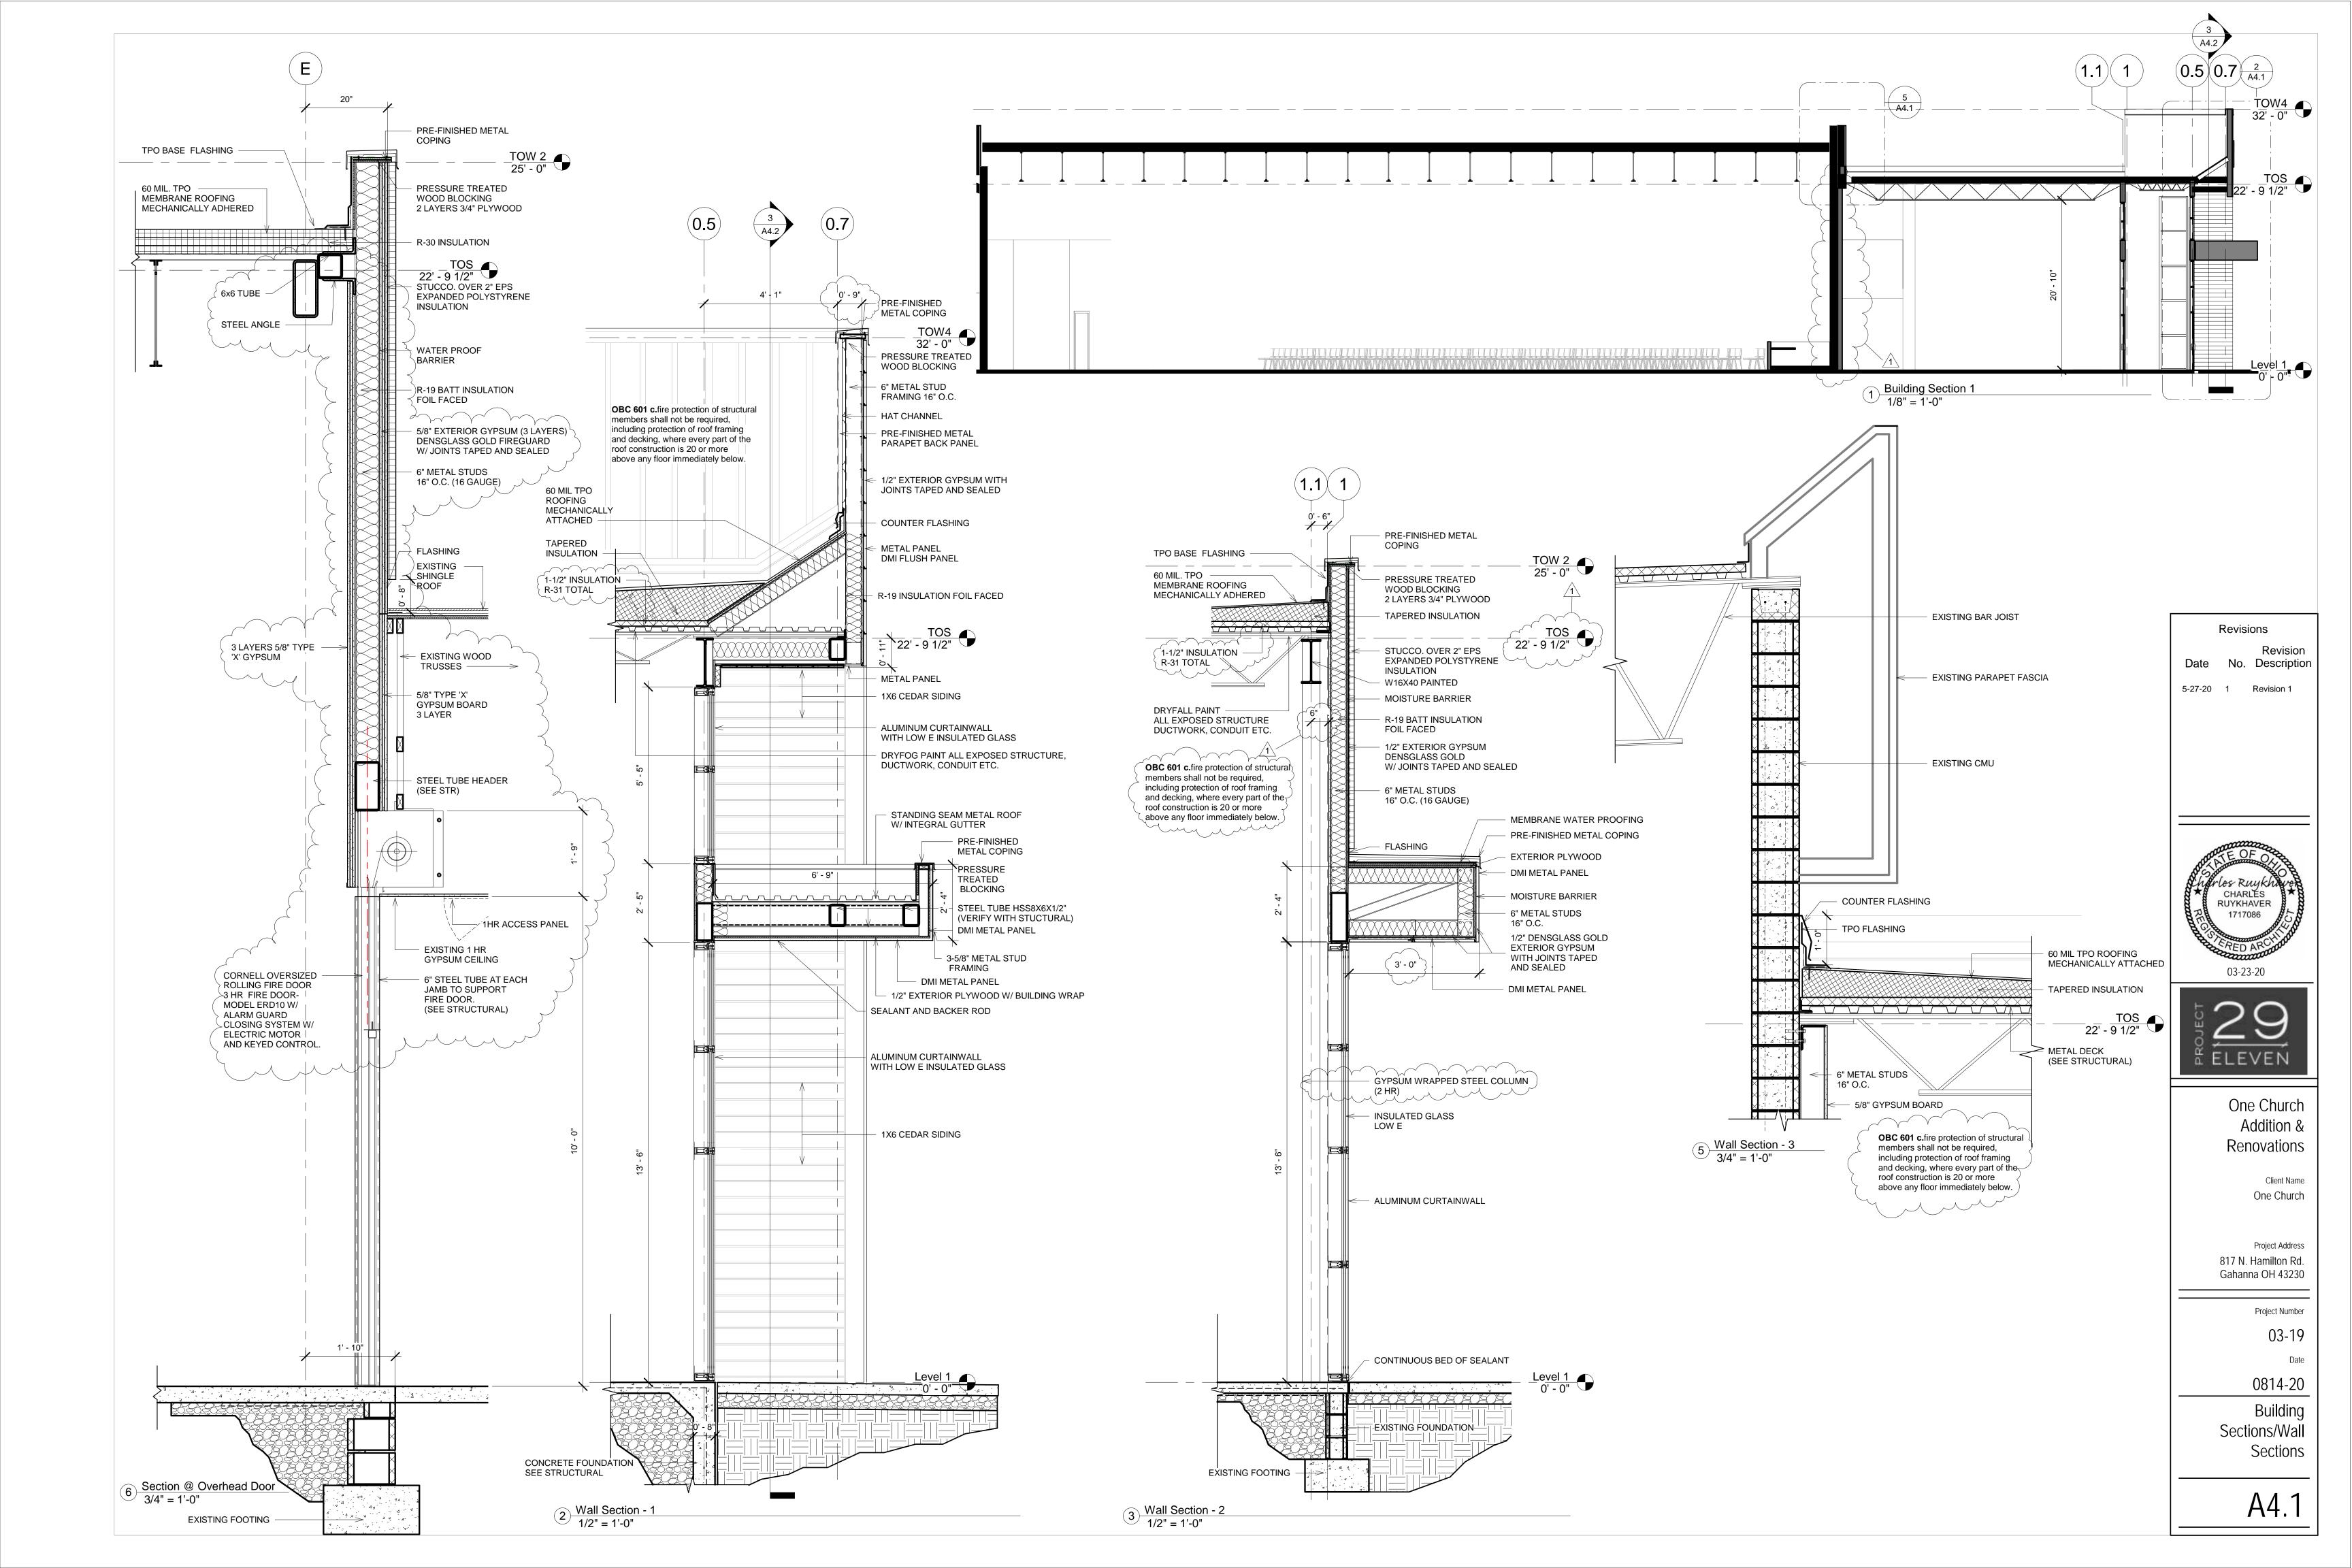

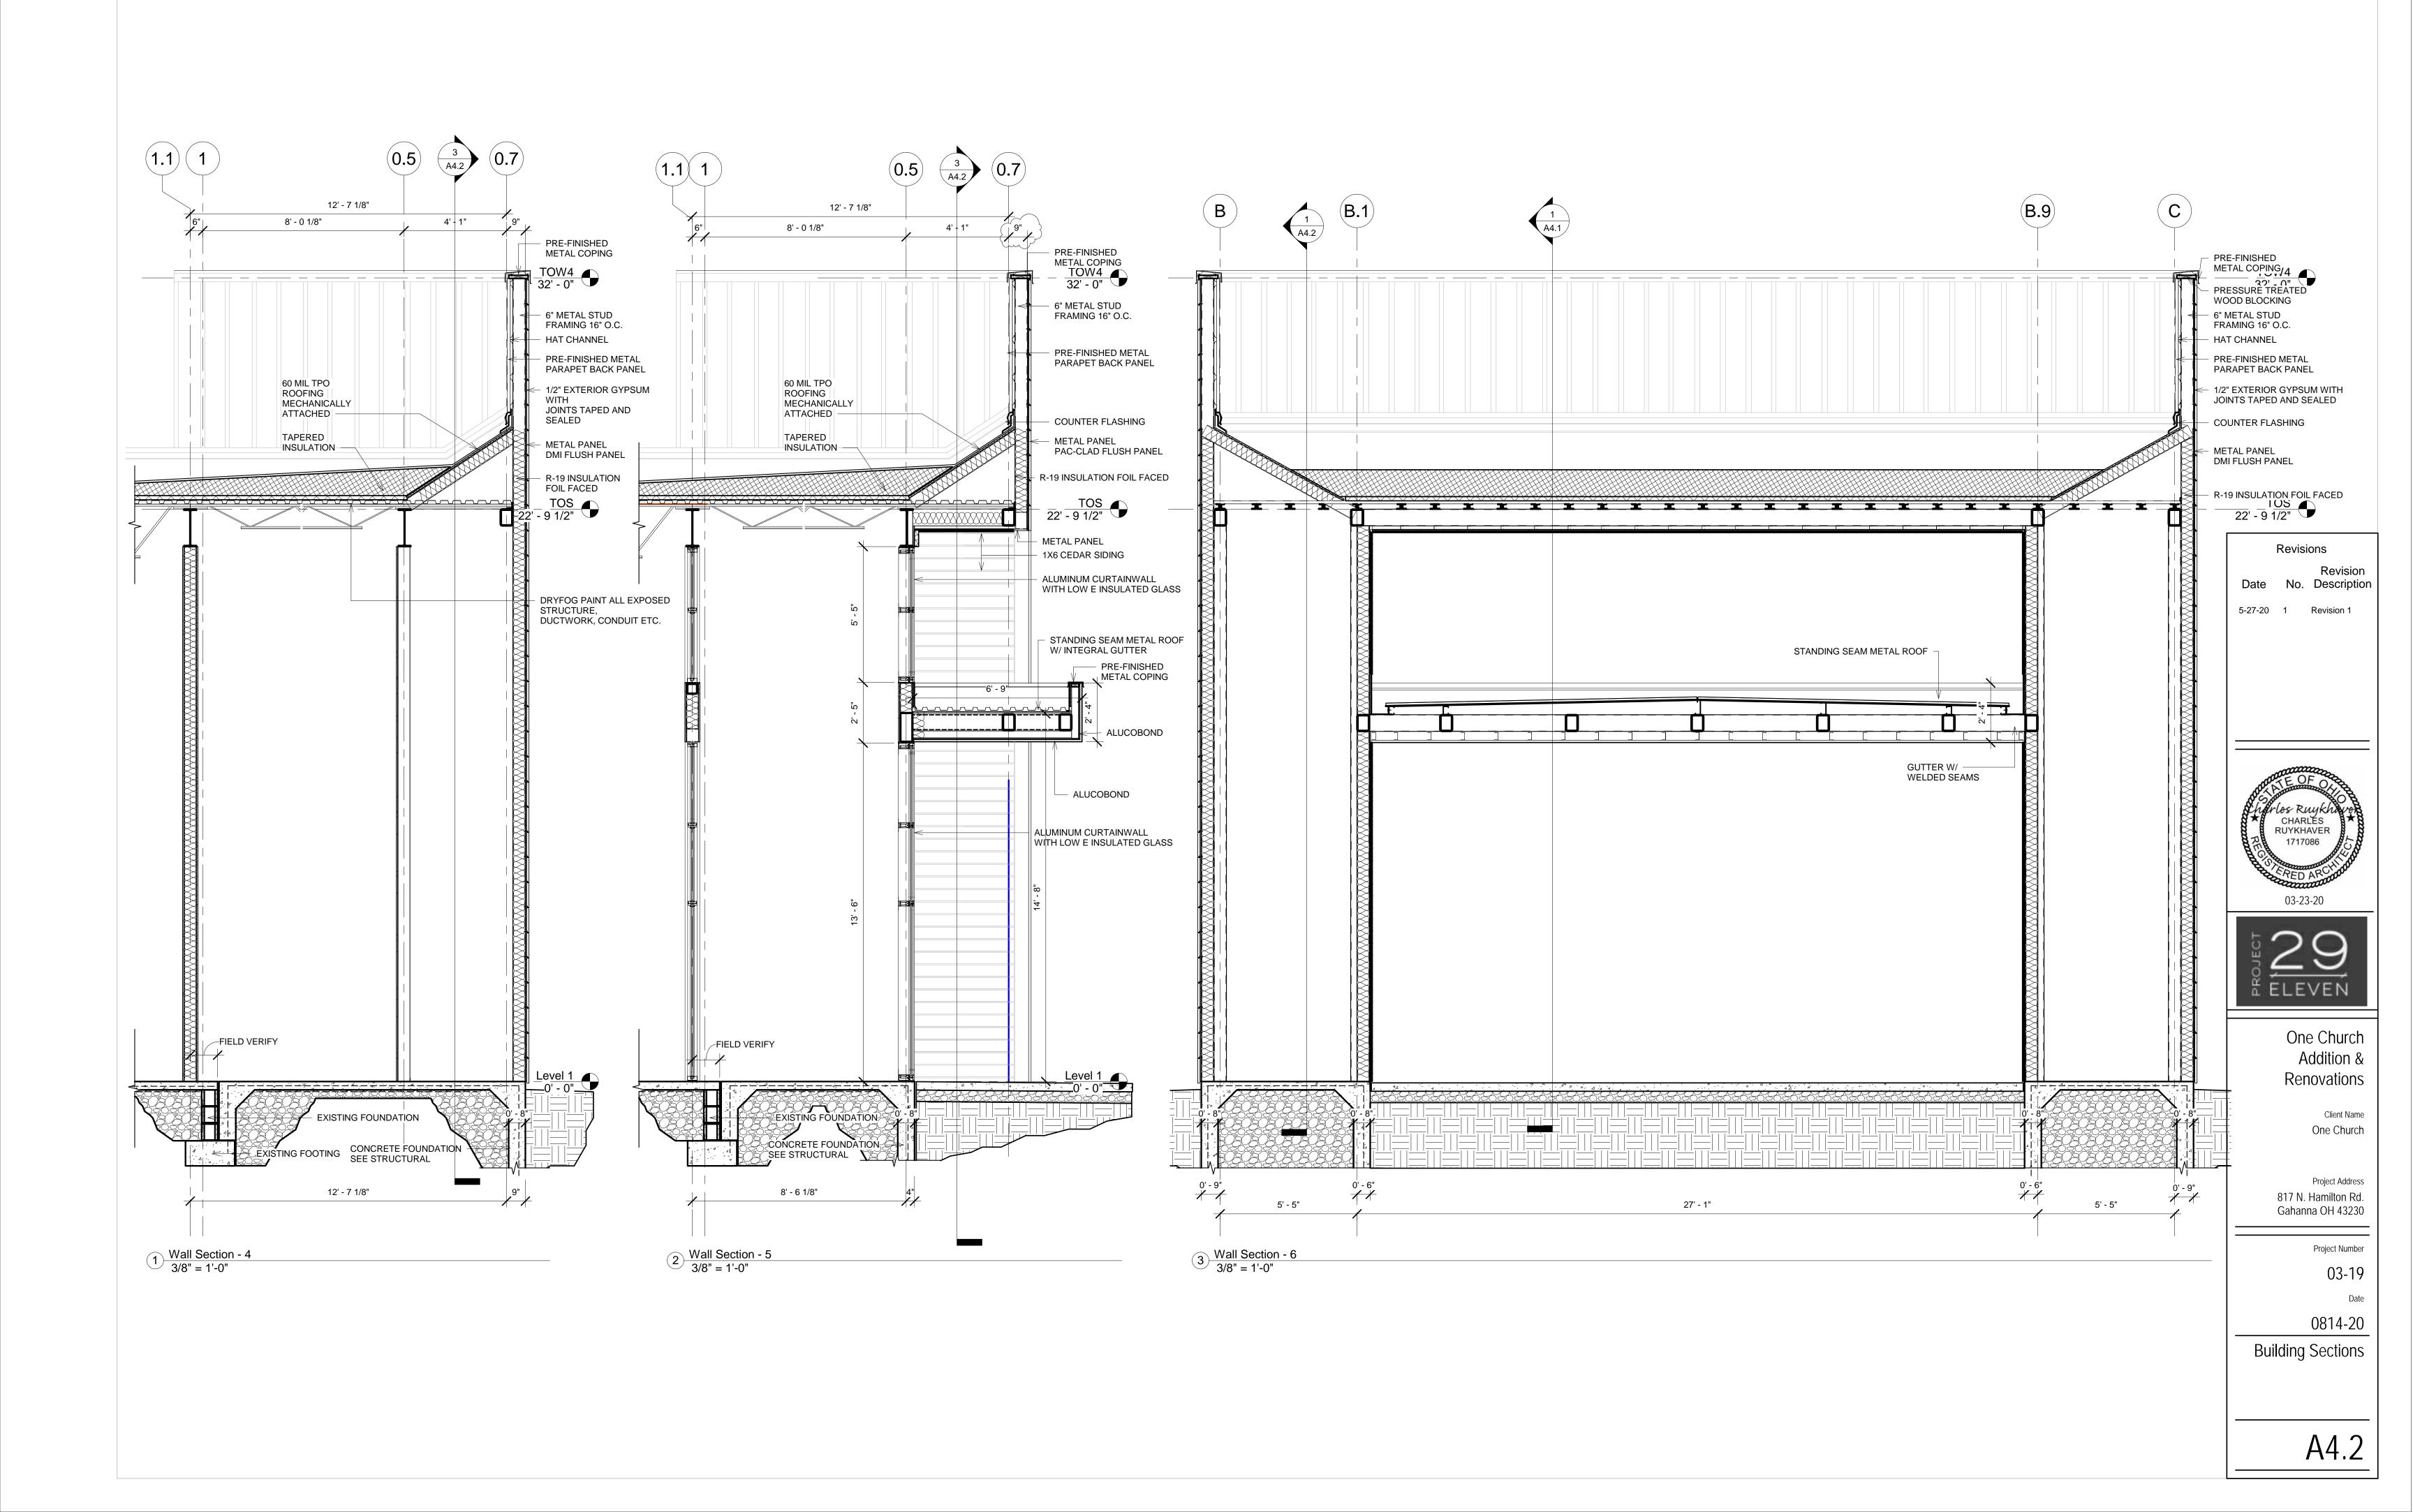

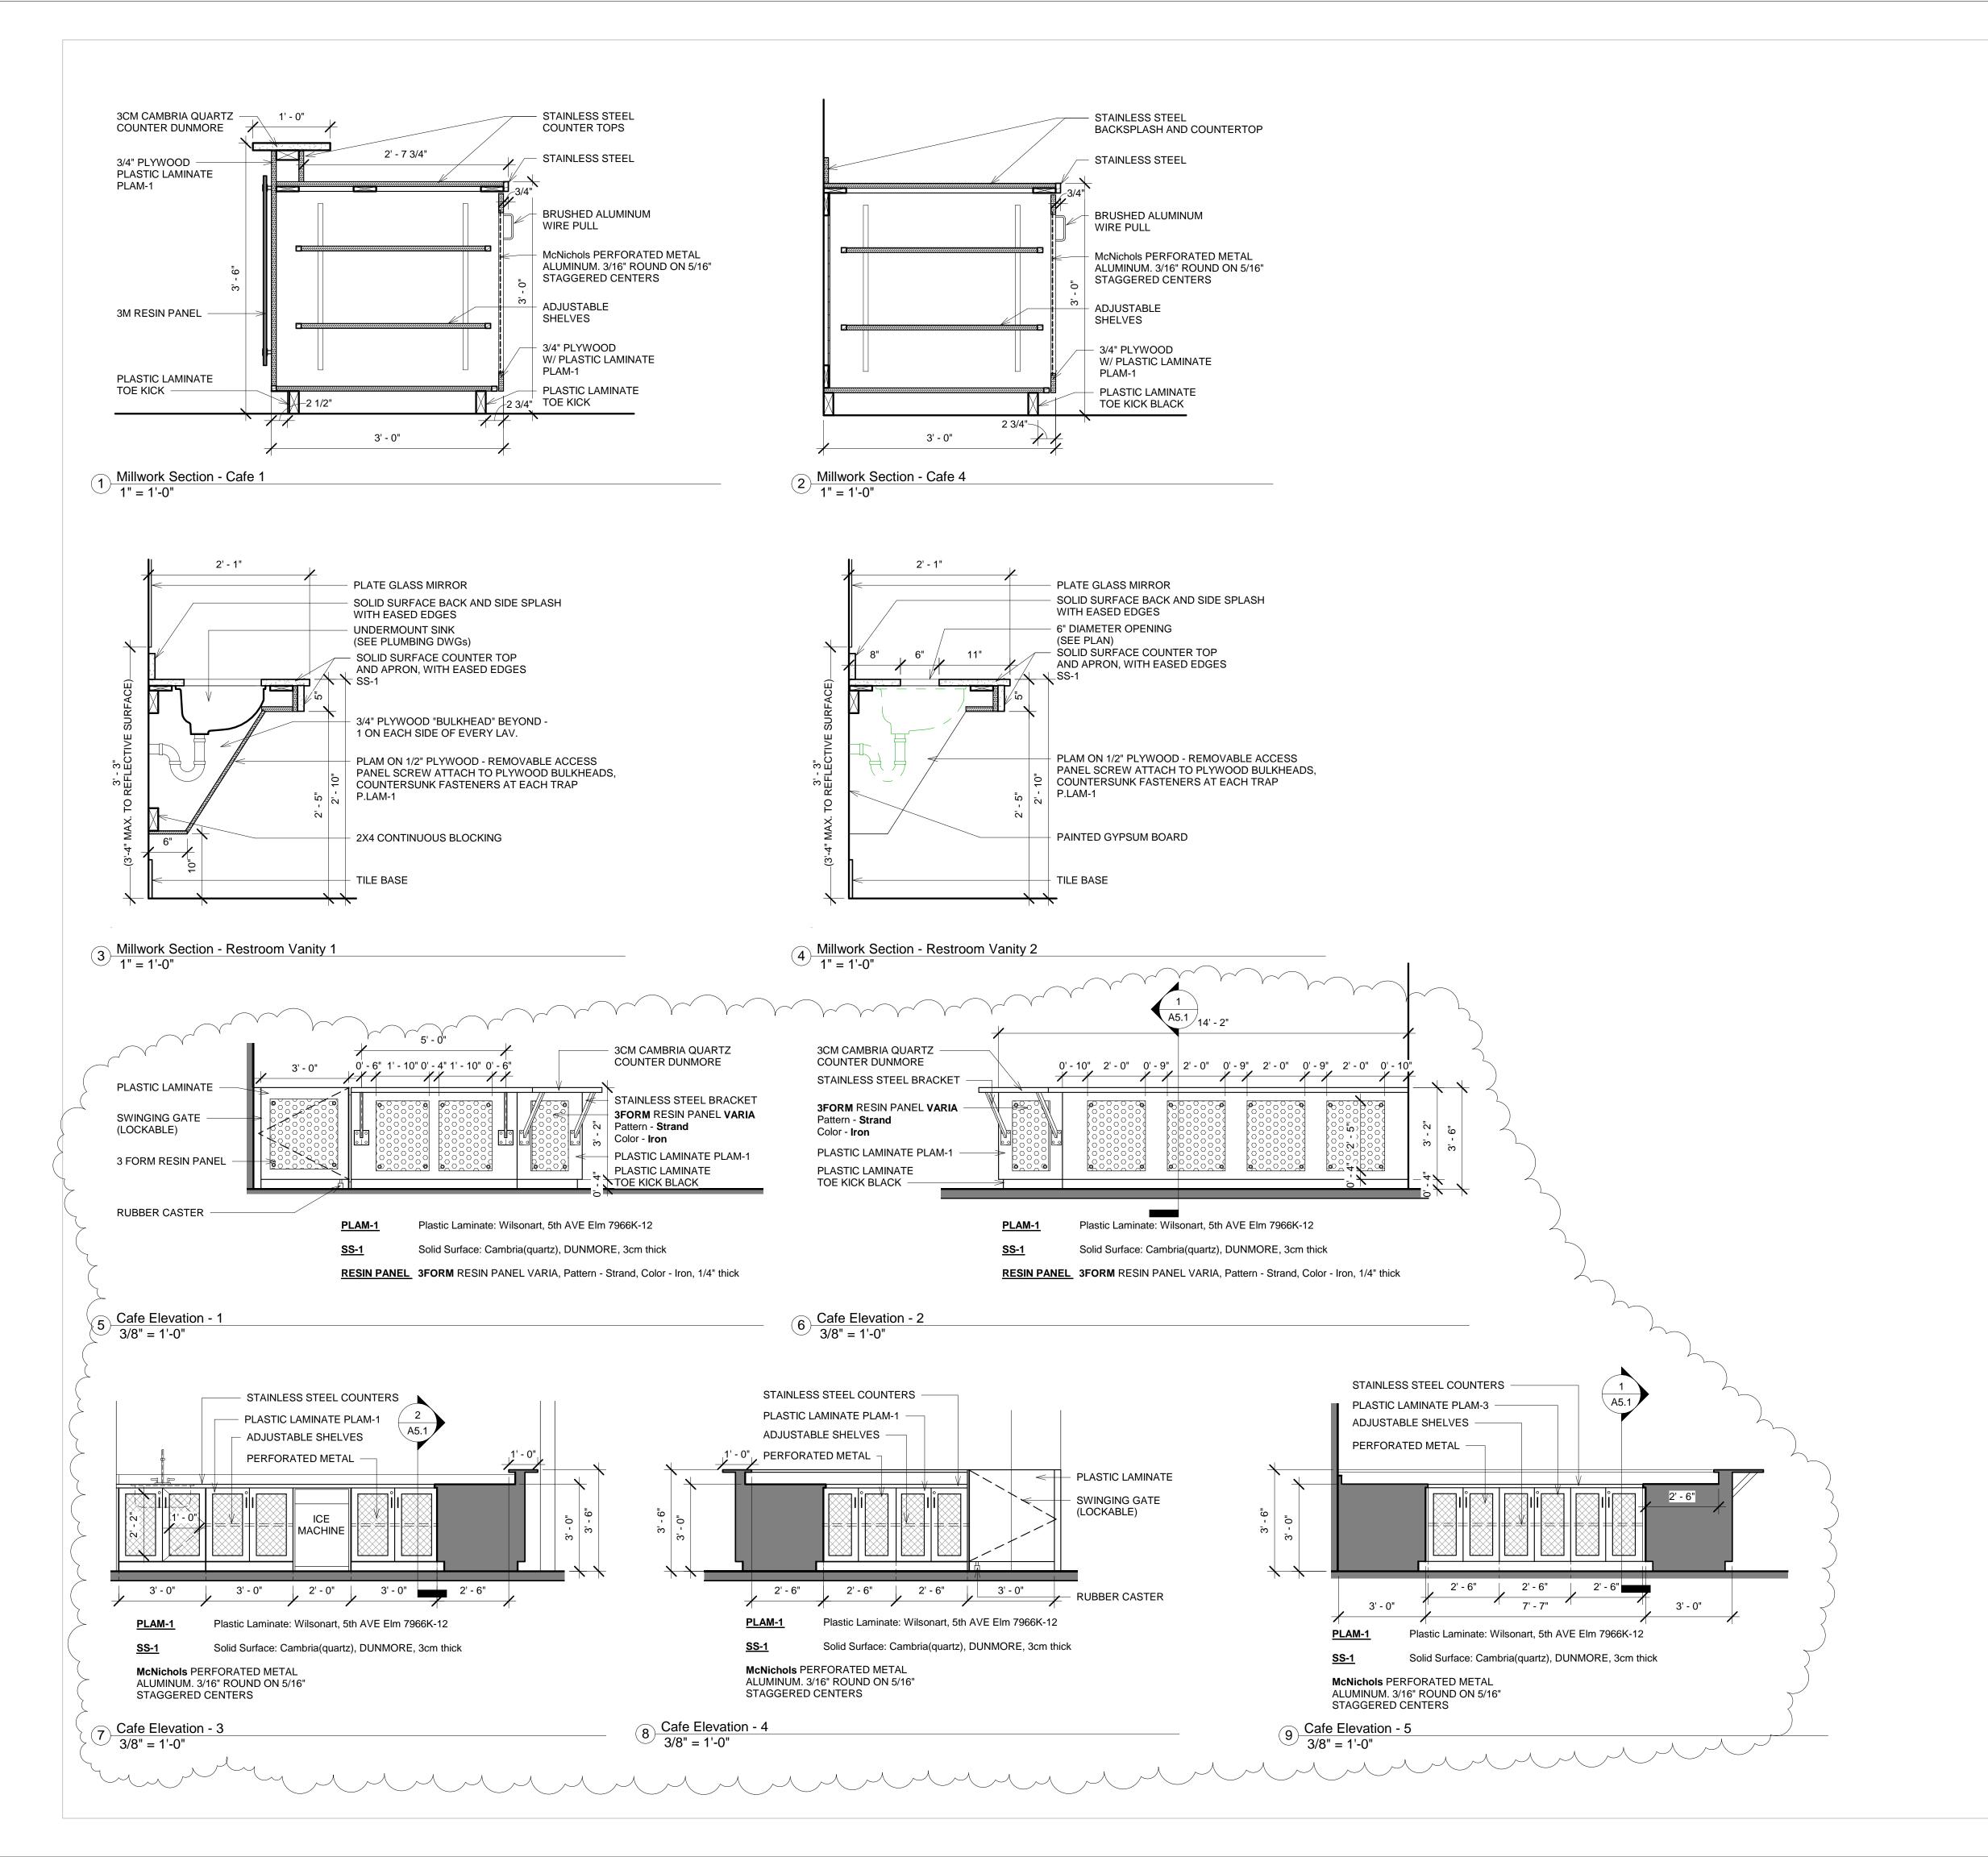

Revisions

Revision
Date No. Description

5-27-20 1 Revision 1

Charles Ruykhaver
CHARLES
RUYKHAVER
1717086

03-23-20



One Church Addition & Renovations

Client Name
One Church


Project Address 817 N. Hamilton Rd. Gahanna OH 43230

Project Number 03-19

Date 0814-20

Millwork Detail

A5.1

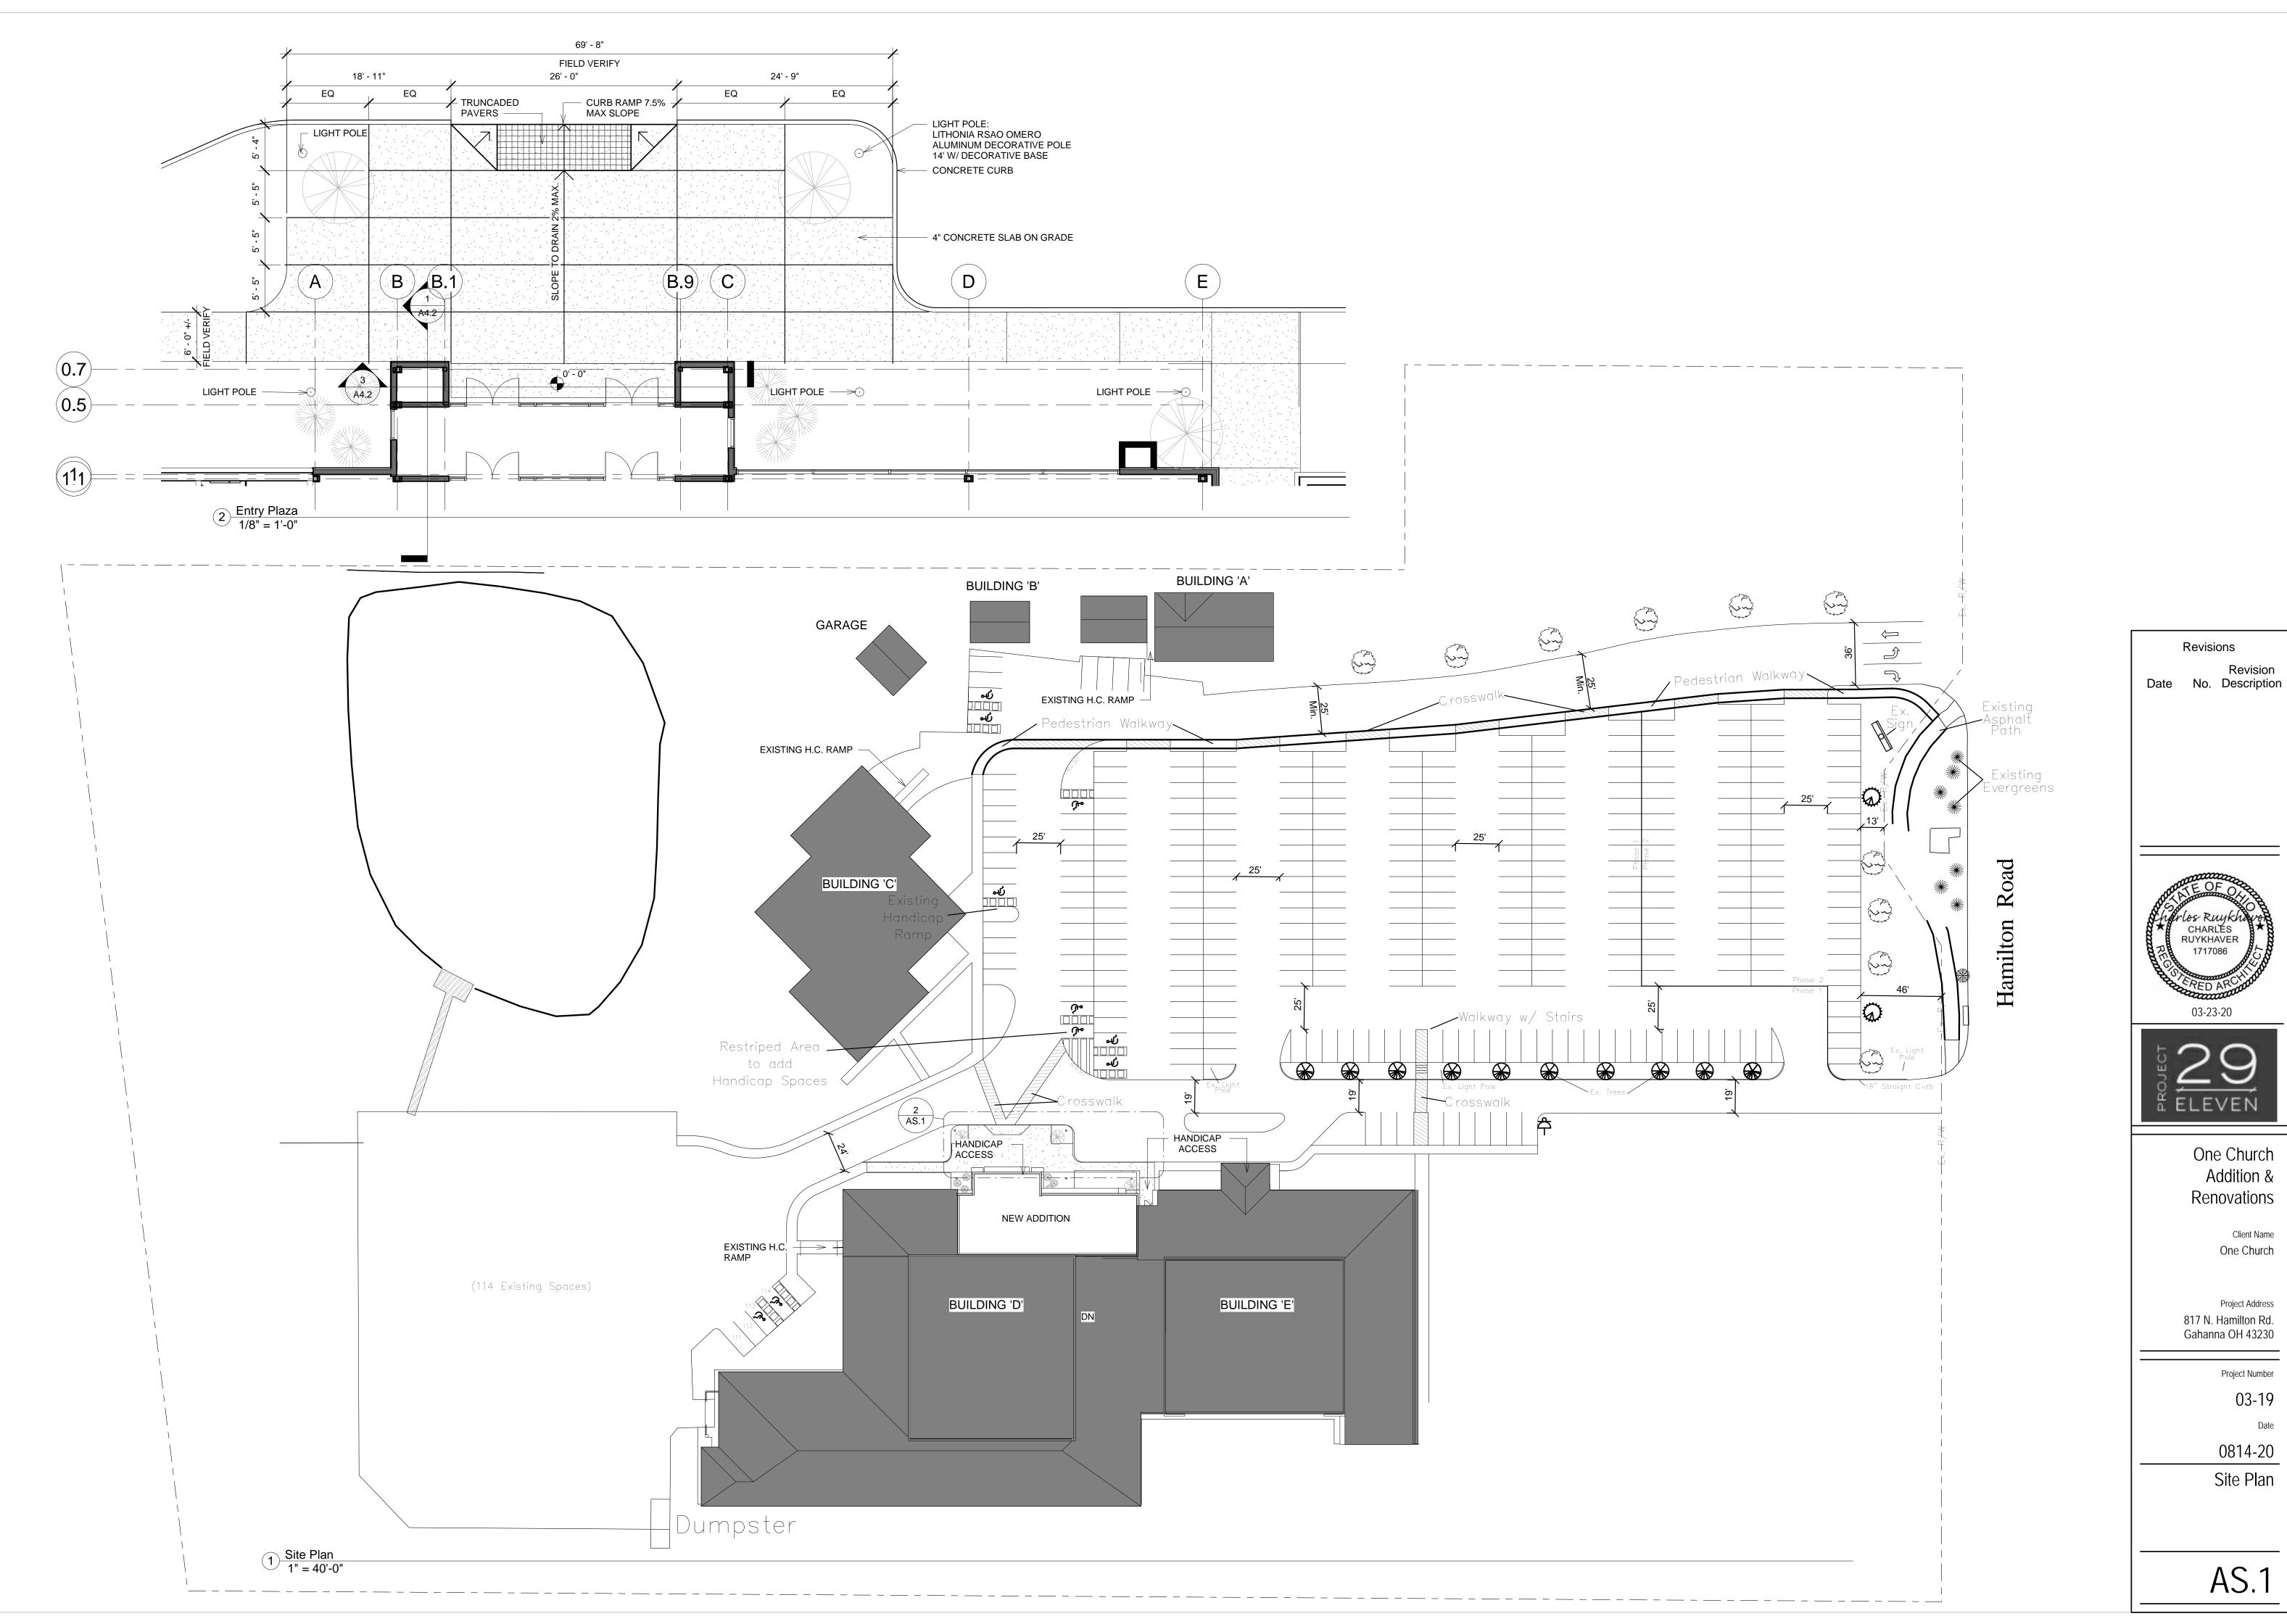









September 14, 2020

One Church 871 N. Hamilton Ave. Gahanna, OH 43230

RE: Project 817 N Hamilton Rd Design Review

Dear One Church:

The following comments were generated from the review of the submitted plans and documents for the referenced project.

#### **Building**

1. Although the revised plans have not been approved yet for compliance with the OBC, there are no issues for this request for approval.

#### **Engineering**

2. No comments at this time.

#### <u>Parks</u>

3. No Comment Per Julie Prederi

#### **Fire District**

4. The fire division has no additional comments to the plan, as we have already submitted plan comments to the building official on the same submitted plans.

#### **Community Development**

5. No comments/concerns.

If you have any comments or questions, please contact me at kelly.wicker@gahanna.gov or (614) 342-4025.

Sincerely,

Kelly Wicker Administrative Assistant



#### PLANNING AND DEVELOPMENT STAFF REPORT

#### **Request Summary**

One Church is requesting a revision to their recently approved design review application. The differences between the two requests is that the façade color is changing from grays to white and trim colors are darker.

#### May 2020 Façade



#### **Proposed Facade**



#### **Design Review**


General review criteria for Design Review applications include the following:



- Are stylistically compatible with other new, renovated, and existing structures in the applicable
  Design Review District in order to maintain design continuity and provide protection of existing
  design environment.
- Contribute to the improvement and upgrading of the architectural and design character of the Design Review District.
- Contribute to the continuing economic and community vitality of the Design Review District
- Maintain, protect and enhance the physical surroundings of the Design Review District.

#### Recommendation

Staff recommends approval of this request. The zoning code does not provide specific color options. It instead states that color palettes should be harmonious with other developments.

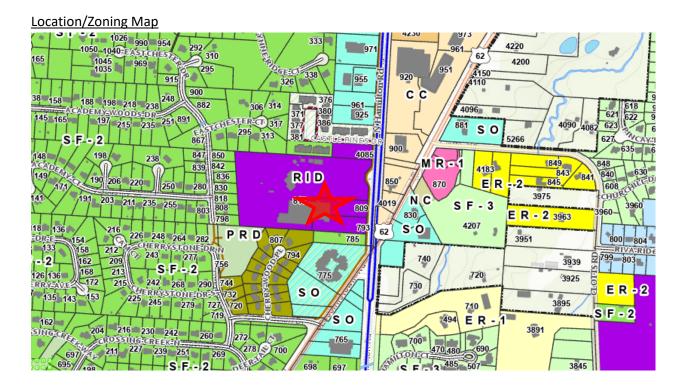

Respectfully Submitted By: Michael Blackford, AICP City Planner/Zoning Administrator